

CIVIL WORKS CARDINIA SHIRE COUNCIL 415 PRINCES HIGHWAY, OFFICER VIC 3809 HILLSTOWE ESTATE, STAGE 4



GENERAL NOTES

- THESE DRAWINGS ARE TO BE READ IN CONJUNCTION WITH EDCM GUIDELINES, CARDINIA SHIRE COUNCIL SPECIFICATIONS AND STANDARD DRAWINGS. WORKS SHALL BE CARRIED OUT TO THE SATISFACTION OF THE SUPERINTENDENT OR HIS/HER REPRESENTATIVE.
- THE COLINCIL AND ALL SERVICE AUTHORITIES SHOULD BE NOTIFIED BY THE CONTRACTOR, COUNCIL AND ALL SERVICE AU INDRINES STUDIED BY THE DISTRIBUTIONS WITHING SEVEN DAYS PRIOR TO COMMENCEMENT OF THE WORKS ALL EXISTING RUICES IN THE VICINITY OF THE WORKS ARE TO BE LOCATED PRIOR TO COMMENCEMENT.
- THE CONTRACTOR SHALL ENSURE THAT NO POLLUTANT OR SEDIMENT LADEN RUNOFF IS DISCHARGED DIRECTLY OR INDIRECTLY INTO ANY DRAINS OR WATER COURSES AND THAT WORKS CONFORM TO THE ENVIRONMENTAL MANAGEMENT PLAN.
- 4 RUNOEE FROM AREAS ON WHICH EARTHWORKS ARE CARRIED OUT MUST BE COLLECTED. NUMBER FROM AREAS ON WHICH SETTING MASS ARE CARRIED ON MUST BE OUDLETED AND TREATED TO THE SATISFACTION OF THE RESPONSIBLE AUTHORITY BY THE USE OF OPEN DRAINS, FILTRATION TRAPS AND RETARDING BASINS IN THE PERIOD BETWEEN THE COMMENCEMENT OF CONSTRUCTION WORKS AND THE END OF THE MAINTENANCE PERIOD IN ACCORDANCE WITH THE ENVIRONMENT MANAGEMENT PLAN FOR THE SUBDIVISION CONSTRUCTION WORKS.
- 5. THE CONTRACTOR SHALL COMPLY WITH ALL OCCUPATIONAL HEALTH AND SAFETY
- AT LEAST 3 DAYS BEFORE COMMENCING EXCAVATION OF TRENCHES IN EXCESS OF 1.5m
 DEPTH, A COMPLETED "NOTICE OF INTENTION TO COMMENCE TRENCHING OPERATIONS"
 FORM SHALL BE SENT TO WORKSAFE VICTORIA. THE MONINATED SUPERVISOR SHALL
 BES UITABLY QUALIFIED IN ACCORDANCE THE VICTORIAN OHS ACT 1985 & COMMONWEALTH OHS CODE OF PRACTICE 2008.
- THE CONTRACTOR SHALL ERECT AND MAINTAIN ALL SHORING PLANKING AND STRUTTING DEWATERING DEVICES, BARRICADES, SIGNS, LIGHTS, ETC., NECESSARY TO KEEP WORKS IN A SAFE AND STABLE CONDITION AND FOR THE PROTECTION OF THE PUBLIC.
- ALL TREES AND SHRUBS ARE TO BE RETAINED UNLESS APPROVAL IS GIVEN BY COUNCIL'S LANDSCAPE OFFICER OR REMOVAL HAS BEEN GRANTED IN A PLANNING PERMIT.
- 9. DISPOSAL OF EXCESS SPOIL:- TRUCK ROUTE AND DISPOSAL LOCATION SHALL BE
- ALL AREAS SHOWN ON THE DRAWINGS TO BE CUT OR FILLED ARE TO BE STRIPPED OF TOPSOIL TO A DEPTH AS SPECIFIED IN GEOTECH SITE GEOTECHNICAL REPORT R7120. UPON COMPLETION OF THE BULK EARTHWORKS, THE TOPSOIL IS TO BE SPREAD TO A DEPTH OF 100mm OVER THE AREA AND GRADED TO FINISHED LEVELS SHOWN ON THE DRAWINGS AND TO THE SATISFACTION OF THE SUPERINTENDENT. ALL FILLING ON LOTS IN EXCESS OF 200mm IS TO BE CARRIED OUT IN ACCORDANCE WITH A.S 3798 APPENDIX B. SECTION B2(A) "LEVEL 1" AT COMPLETION, THE CONTRACTOR SHALL PRESENT A SOIL REPORT FROM A LEVEL 1: AT COMPLETION, THE CONTRACTOR SMALL PRESENT A SOIL REPORT FROM A NA.T.A TESTING AUTHORITY, NOMINATING THE EXTENT OF FILL AND ITS CONFORMANCE WITH THE SPECIFICATION. FILLING TO BE CARRIED OUT USING APPROVED MATERIAL. TOPSOIL AND ALL VEGETABLE MATERIAL TO BE STRIPPED FROM FILL SITE PRIOR TO ANY PLACEMENT OF MATERIAL. ALL FILLING IS TO BE COMPACTED IN 150mm. MAX. DEPTH LAYERS TO 95% OF AS1289.5.1.1 (STANDARD COMPACTION).
- 11. ALL STORMWATER DRAINS ARE TO BE CLASS '2' RC OR FRC PIPES UNLESS OTHERWISE SHOWN, ALL RC PIPES UP TO AND INCLUDING 750mm DIA, ARE TO BE RUBBER RING JOINTED, INTERLOCKING / FLUSH JOINTS WITH EXTERNAL BANDS MAY BE USED ON PIPES OVER DIA. WITH APPROVAL FROM CARDINIA SHIRE COUNCIL
- 12. TELECOMM. CONDUITS AND CABLE DUCTS WILL BE LAID IN TRENCHES EXCAVATED AND BACKFILLED BY THE CONTRACTOR. THE CONTRACTOR SHALL GIVE THE TELECOMM. AUTHORITY AREA ENGINEER 7 DAYS NOTICE PRIOR TO COMMENCING WORK.
- 13. 100mm DIAMETER AGRICULTURAL DRAINS TO BE CONSTRUCTED BEHIND ALL KERB AND CHANNEL IN ACCORDANCE WITH EDCM 202 AND LAID WITH CLEARANCE TO ALL SERVICE
- WHERE DRAINAGE PIPES ARE LAID ON A CURVE THE BUILDING LINE IS TO BE PEGGED AT 15m INTERVALS.
- 15. THE REINSTATEMENT AND COMPACTION OF SERVICE AUTHORITY TRENCHES SHALL BE THE
- ALL P.S.M.s SHALL BE HIGH STABILITY TYPE AND LEVELLED BY A LICENSED SURVEYOR AND THE P.S.M. DATA SHALL BE FORWARDED TO COUNCIL.
- 17. ALL CONDUIT ENDS SHALL BE PLUGGED WITH DRAW WIRE AS APPROPRIATE.
- 18. ALL DRAINAGE TRENCHES WITHIN 5.0m OF ANY TREE TO BE RETAINED SHALL BE THRUST
- 19. FILL MATERIAL UNDER ROAD PAVEMENT SHALL BE APPROVED MATERIAL AND DONSTRUCTED IN LAYERS OF 150mm THICKNESS WITH COMPACTION ACHIEVING 98% STANDARD COMPACTION) AT THE EQUILIBRIUM MOISTURE CONTENT OR -1% TO +3% OF
- 20. ALL LINEMARKING AND SIGNAGE SHALL BE IN ACCORDANCE WITH AS1742.1 AND AS1742.2. LONG LIFE PAINT SHALL BE USED FOR LINEMARKING
- 21. ALL ELECTRICITY CONDUITS ARE TO BE A MINIMUM 63mm DIAMETER. ALL TELSTRA NDUITS ARE TO BE A MINIMUM 100mm DIAMETER. REFER TO ELECTRICAL AND
- 22. THE CONTRACTOR SHALL NOTE THE EXISTENCE OF TELECOMMUNICATIONS, GAS POWER, WATER AND ANY OTHER SERVICES IN THE AREA PRIOR TO TENDERING / CONSTRUCTION.
- 23. ANY DISTURBANCE TO EXISTING INFRASTRUCTURE DUE TO CONSTRUCTION WORKS SHALL BE RECTIFIED AT THE CONTRACTOR'S EXPENSE.
- ALL NATURE STRIPS AND BATTERS SHALL BE COVERED WITH 100mm MIN. DEPTH TOPSOIL
- a. CONDUITS UNDER FOOTPATHS TO BE 450mm DEEP EXTENDING 250mm FITHER SIDE OF THE PATH. THE FOOTPATH ABOVE THE CONDUITS SHALL BE MARKED WITH TWO
- THE PATH. THE POOTPATH ABOVE THE CONDUITS SHALL BE MARKED WITH TWO CONTRACTION JOINTS OVER THE CONDUITS 400mm APART.

 b. CONDUITS SHALL BE REFERENCED ON BOTH FOOTPATH AND KERB & CHANNEL.

 c. CONDUITS INSTALLED UNDER ROAD PAVEMENTS SHALL EXTEND 1 METRE INSIDE THE ALLOTMENTS WHERE FOOTPATH IS PROPOSED.

 d. GAS TO BE 50mm DIA, CLASS 12 PVC & WATER CONDUIT TO BE DN100, SINGLE CONDUIT CONTRACTION.
- CONTAINING BOTH DW & NDW SERVICES LAID IN ACCORDANCE WITH WSA 03-2011-3.1 AND DRAWING MRWA-W-202 & MRWA-W-110.
- 27. UPON COMPLETION OF THE WORKS THE WHOLE SITE SHALL BE CLEANED AND ALL RUBBISH

- NO TOPSOIL SHALL BE REMOVED FROM THE SITE
- INSPECTIONS SHALL BE ARRANGED A MINIMUM OF 24 HOURS BEFORE WITH COUNCILS ASSETS ENGINEER.
- 30. STREET SIGNS SHALL BE MANUFACTURED IN ACCORDANCE WITH CARDINIA SHIRE COUNCIL STANDARDS INCLUDING LOGO AND TO COMPRISE TWO FINGER BOARDS.
- 31. 24 HOURS NOTICE IS REQUIRED FOR INSPECTION AT THE FOLLOWING HOLD POINTS
- PRIOR TO COMMENCEMENT OF THE WORKS.
- INSPECTION OF THE SUBGRADE.
- INSPECTION DURING DRAINAGE WORKS INSPECTION PRIOR TO POURING OF PITS

- INSPECTION OF SUB SOIL DRAINAGE.
 INSPECTION OF SUB SOIL DRAINAGE.
 INSPECTION OF KERB AND CHANNEL BEDDING.
 INSPECTION PRIOR TO ANY CONCRETE WORKS.
 INSPECTION AND TESTING OF EACH PAVEMENT LAYER (BY DEVELOPER OR CONTRACTOR) PRIOR TO PLACING ANY SUBSEQUENT PAVEMENT LAYER. COMPACTION TEST RESULTS SHALL BE ISSUED TO COUNCIL.
- INSPECTION PRIOR TO SEALING AND ASPHALT WORKS.
- 32. COUNCIL WILL NOT ACCEPT ANY RESPONSIBILITY FOR WORKS WHERE AN INSPECTION IS NOT UNDERTAKEN WITH A COUNCIL APPOINTED REPRESENTATIVE.
- 33. ALL DIMENSIONS ARE IN METRES AND RADII TO LIP OF KERB UNLESS OTHERWISE SHOWN.
- 34. LEVELS ARE TO A.H.D. AND TAKEN FROM LEVEL PLANS BY TAYLORS DEVELOPMENT STRATEGISTS. SETOUT CO-ORDINATES ARE BASED ON MGA ZONE 55.
- 35. PITS SHALL BE LOCATED USING OFFSETS AND CO-ORDINATES SHOWN ON DRAWINGS.
- ALL DRAINS BENEATH ROAD PAVEMENT, PATHS, DRIVEWAYS AND PARALLEL TO KERB SHALL BE BACKFILLED WITH 20mm CLASS 2 F.C.R. ALL BACKFILLING TO BE COMPACTED TO 98% OF AS1289.5.1.1 (STANDARD COMPACTION). DRAINS BEHIND THE BACK OF KERB SHALL BE BACKFILLED USING SELECT FILL. COMPACTION OF THE DRAINAGE LINE SHALL BE 95% STANDARD COMPACTION TO AS1289.5.1.1 AND ALL TEST RESULTS SHALL BE SUBMITTED TO
- HOUSE DRAINS SHALL GENERALLY BE PLACED 5.5m FROM THE LOW CORNER OF THE LOT, AS PER EDOM 701 AND PROPERTY INLETS 1.0m FROM AND 0.6m BELOW THE LOW CORNER OF THE LOT, UNLESS OTHERWISE SHOWN.
- 38. HOUSE NUMBERS TO BE STENCILED ON THE FACE OF KERB IN 100mm HIGH LETTERS.
- 39 EXISTING OPEN CHANNELS TO BE EXCAVATED TO A FIRM BASE AND BACKFILLED IN ACCORDANCE WITH NOTE 10. CONSULTING ENGINEER TO BE NOTIFIED WHEN THE OPEN CHANNELS HAVE BEEN EXCAVATED TO A FIRM BASE, NO FILLING IS TO BE PLACED PRIOR INNELS TAVE BEEN EXCAVATED TO A FINAND BASE. NO FILLING IS TO BE CARRIED OUT TO THE IS BEING INSPECTED AND LEVELS TAKEN. BACKFILLING IS TO BE CARRIED OUT TO THE ISFACTION OF THE SUPERINTENDENT.
- 40. ALL PAVEMENT MATERIALS ARE TO BE APPROVED BY CARDINIA SHIRE COUNCIL
- 41. ALL PAVEMENTS ARE TO BE TESTED FOR ADEQUATE COMPACTION AND APPROVED PRIOR
- 42. PRIOR TO THE ISSUE OF A STATEMENT OF COMPLIANCE, ALL NEWLY CONSTRUCTED ROADS, FOOTPATHS AND DRAINAGE ASSETS ARE TO BE RECORDED UNDER THE "D-SPEC" & "R-SPEC" SYSTEM AS SETOUT IN THE EDCM GUIDELINES AND THE RESULTS PROVIDED TO CARDINIA SHIRE COUNCIL.
- 43. NO FILL OR EXCAVATED MATERIAL FOR OR FROM THIS DEVELOPMENT IS TO BE CARTED/HAULED INTO OR FROM THE SITE, WITHOUT FIRST OBTAINING THE FURTHER WRITTEN CONSENT FROM COUNCIL'S ENGINEERING DEPARTMENT AT LEAST SEVEN (7) DAYS PRIOR TO THE CARTAGE/HAULAGE WORKS COMMENCING, TO THE SATISFACTION OF
- 44. ALL EARTHWORKS MUST BE UNDERTAKEN IN A MANNER THAT MINIMISES SOIL EROSION, AND ANY EXPOSED AREAS OF SOIL MUST BE STABILISED TO PREVENT SOIL EROSION TO THE SATISFACTION OF THE RESPONSIBLE AUTHORITY
- 45. EROSION MUST BE CONTROLLED DURING CONSTRUCTION IN ACCORDANCE WITH THE ENVIRONMENT PROTECTION AUTHORITY GUIDELINE TG208/90. CONTRACTOR TO PROVIDE SITE EMP.
- 46. ALL VEGETATION THAT IS REMOVED AND DISPOSED OF MUST:
 - a. NOT CAUSE DAMAGE TO VEGETATION STANDS TO BE RETAINED. b. HAVE REGARD TO THE LOCAL LAW WHEN BURNING VEGETATION
- 47 NATIVE VEGETATION REMOVAL TO BE LIMITED TO THE SPECIFIC PLANTS IDENTIFIED AS NATIVE VEGETATION REMOVAL TO BE LIMITED TO THE SPECIFIC PLANTS IDENTIFIED A PART OF THE PLANNING PERMIT. NO ADDITIONAL NATIVE PLANTS, OUTSIDE OF THOSE SPECIFIED IN THE PLANNING PERMIT, ARE TO BE REMOVED.
- 48. NO POLLUTED AND/OR SEDIMENT LADEN RUNOFF IS TO BE DISCHARGED, DIRECTLY OR INDIRECTLY, INTO MELBOURNE WATER'S DRAINS OR WATERCOURSES.
- 49. BEFORE THE VEGETATION REMOVAL STARTS, THE BOUNDARIES OF ALL VEGETATION TO BE REMOVED AND RETAINED MUST BE CLEARLY MARKED WITH TEMPORARY FENCING. TO THE SATISFACTION OF THE RESPONSIBLE AUTHORITY. THE REMOVAL MUST BE IN ACCORDANCE
- 50. PRIOR TO FELLING, TREES IDENTIFIED FOR REMOVAL MUST BE EXAMINED FOR THE PRESENCE OF FAUNA, INCLUDING THOSE USING EXTERNAL NESTS (e.g COMMON RINGTAIL POSSUMS, BIRDS NESTS) AND TREE HOLLOWS. IF NATIVE FAUNA SPECIES ARE LOCATED, THEY ARE TO BE SALVAGED AND RELOCATED IN ACCORDANCE WITH ALL RELATIVE LEGISLATION AND APPROVALS, FURTHER TO CONSULTATION WITH THE DEPARTMENT OF SUSTAINABILITY AND ENVIRONMENT
- ALL VEHICLES, EARTHMOVING EQUIPMENT AND OTHER MACHINERY MUST BE CLEARED OF SOIL AND PLANT MATERIAL BEFORE ENTERING AND LEAVING THE SITE, TO PREVENT THE SPREAD OF WEEDS AND PATHOGENS
- 52. DRIVEWAYS TO BE EXCAVATED INTO ALL OTMENTS AT A MAXIMUM GRADE OF 1 IN 6 WHERE BATTERS EXCEED 6
- 53. DRIVEWAY LAYBACK AND WINGS ARE TO BE CONSTRUCTED AS A SINGLE SEGMENT OF
- 54. ALL NBN PITS ARE TO BE CLEAR OF PATHS AND DRIVEWAYS.
- 55 CONTRACTOR TO PROVIDE CCTV TESTING ON ALL CONSTRUCTED DRAINAGE LINES AND TO BE APPROVED BY COUNCIL PRIOR TO THE ISSUE OF STATEMENT OF COMPLIANCE
- ALL RESIDENTIAL AND HEAVY DUTY DRIVEWAYS TO BE CONSTRUCTED ACCORDING TO

	DRAWING INDEX	
DRAWING NO.	DESCRIPTION	SHEET NO
01177-04-E-000	COVER SHEET	0
01177-04-E-100	GENERAL NOTES, LOCALITY PLAN, DRAWING INDEX & SERVICE OFFSET TABLE	1
01177-04-E-101	EXISTING FEATURES PLAN SHEET 1 OF 3	2
01177-04-E-102	EXISTING FEATURES PLAN SHEET 2 OF 3	3
01177-04-E-103	EXISTING FEATURES PLAN SHEET 3 OF 3	4
01177-04-E-104	TYPICAL SECTIONS	5
01177-04-E-105	TYPICAL DETAILS	6
01177-04-E-106	OVERALL STAGING PLAN	7
01177-04-E-107	ROAD CENTRELINE SETOUT PLANS	8
01177-04-E-108	PLAN OF SUBDIVISION	9
01177-04-E-109	DETAIL LAYOUT PLAN SHEET 1 OF 3	10
01177-04-E-110	DETAIL LAYOUT PLAN SHEET 2 OF 3	11
01177-04-E-111	DETAIL LAYOUT PLAN SHEET 3 OF 3	12
01177-04-E-112	ROAD LONGITUDINAL SECTIONS SHEET 1 OF 5	13
01177-04-E-113	ROAD LONGITUDINAL SECTIONS SHEET 2 OF 5	14
01177-04-E-114	ROAD LONGITUDINAL SECTIONS SHEET 3 OF 5	15
01177-04-E-115	ROAD LONGITUDINAL SECTIONS SHEET 4 OF 5	16
01177-04-E-116	ROAD LONGITUDINAL SECTIONS SHEET 5 OF 5	17
01177-04-E-117	ROAD CROSS SECTIONS SHEET 1 OF 10	18
01177-04-E-118	ROAD CROSS SECTIONS SHEET 2 OF 10	19
01177-04-E-119	ROAD CROSS SECTIONS SHEET 3 OF 10	20
01177-04-E-120	ROAD CROSS SECTIONS SHEET 4 OF 10	21
01177-04-E-121	ROAD CROSS SECTIONS SHEET 5 OF 10	22
01177-04-E-122	ROAD CROSS SECTIONS SHEET 6 OF 10	23
01177-04-E-123	ROAD CROSS SECTIONS SHEET 7 OF 10	24
01177-04-E-124	ROAD CROSS SECTIONS SHEET 8 OF 10	25
01177-04-E-125	ROAD CROSS SECTIONS SHEET 9 OF 10	26
01177-04-E-126	ROAD CROSS SECTIONS SHEET 10 OF 10	27
01177-04-E-127	INTERSECTION DETAILS AND KERB LIP PROFILES SHEET 1 OF 4	28
01177-04-E-128	INTERSECTION DETAILS AND KERB LIP PROFILES SHEET 2 OF 4	29
01177-04-E-129	INTERSECTION DETAILS AND KERB LIP PROFILES SHEET 3 OF 4	30
01177-04-E-130	INTERSECTION DETAILS AND KERB LIP PROFILES SHEET 4 OF 4	31
01177-04-E-131	SIGNS AND LINEMARKING PLAN SHEET 1 OF 2	32
01177-04-E-132	SIGNS AND LINEMARKING PLAN SHEET 2 OF 2	33
01177-04-E-133	RETAINING WALL SETOUT DETAIL SHEET 1 OF 3	34
01177-04-E-134	RETAINING WALL SETOUT DETAIL SHEET 2 OF 3	35
01177-04-E-135	RETAINING WALL SETOUT DETAIL SHEET 3 OF 3	36
01177-04-E-136	RETAINING WALL DETAILS SHEET 1 OF 2	37
01177-04-F-137	RETAINING WALL DETAILS SHEET 2 OF 2	38
01177-04-E-138	RESERVE FOOTPATH SETOUT PLAN	39
01177-04-E-139	TEMPORARY RETARDING BASIN DETAILS	40
01177-04-E-140	DRAINAGE LONGITUDINAL SECTIONS SHEET 1 OF 6	41
01177-04-E-141	DRAINAGE LONGITUDINAL SECTIONS SHEET 1 OF 6	42
01177-04-E-141	DRAINAGE LONGITUDINAL SECTIONS SHEET 2 OF 6	43
01177-04-E-142	DRAINAGE LONGITUDINAL SECTIONS SHEET 4 OF 6	44
01177-04-E-143	DRAINAGE LONGITUDINAL SECTIONS SHEET 4 OF 6 DRAINAGE LONGITUDINAL SECTIONS SHEET 5 OF 6	45
01177-04-E-144	DRAINAGE LONGITUDINAL SECTIONS SHEET 6 OF 6	46
01177-04-E-146	DRAINAGE ECHONOS SILEET VOT V	47

BVD S St.Brigids Cath Prim Sch Vineyard Drangelo Estate Vineyard D
I OCALITY PLAN

LOCALITY PLAN N.T.S.

			SE	RVICE O	FFSET	TABLE						
STREET	GAS		RECYCLED WATER (NDW)		POTABLE WATER (DW)		TELECOMS		ELECTRICAL CABLES		SEWER	
	SIDE	OFFSET	SIDE	OFFSET	SIDE	OFFSET	SIDE	OFFSET	SIDE	OFFSET	SIDE	OFFSET
EVERFAIR CRESCENT (LOTS 418-426 & 401)	EAST	2.10m	EAST	2.50m	EAST	3.10m	WEST	1.00m	WEST	2.60m	WEST	1.80m (EXISTING)
TARKINE STREET	EAST	2.10m	EAST	2.50m	EAST	3.10m	WEST	1.00m	WEST	2.60m	WEST	1.80m (EXISTING)
EVERFAIR CRESCENT (LOTS 412-418 & 434-437)	NORTH	2.10m	NORTH	2.50m	NORTH	3.10m	SOUTH	1.80m	SOUTH	2.60m	NORTH SOUTH	1.00m 1.00m
CLEARFELL STREET (LOTS 403-412)	WEST	2.10m	WEST	2.50m	WEST	3.10m	EAST	1.80m	EAST	2.60m	WEST	1.00m
CLEARFELL STREET (LOTS 401-403)	SOUTH	1.95m	SOUTH	2.35m	SOUTH	2.95m	NORTH	1.00m	NORTH	0.50m	-	-
KIELDER STREET	EAST	2.10m	EAST	2.50m	EAST	3.10m	WEST	1.80m	WEST	2.60m	-	-
SAWMILLER STREET	EAST	2.10m	EAST	2.50m	EAST	3.10m	WEST	1.80m	WEST	2.60m	WEST	1.00m
GONDWANA STREET	EAST	2.10m	EAST	2.50m	EAST	3.10m	WEST	1.80m	WEST	2.60m	-	-
APPLEBUSH WALK	SOUTH	1.85m	SOUTH	2.25m	SOUTH	2.75m	SOUTH	3.35m	SOUTH	3.75m	-	-



SERVICE OFFSET TABLE												
STREET	GAS		RECYCLED WATER (NDW)		POTABLE WATER (DW)		TELECOMS		ELECTRICAL CABLES		SEWER	
	SIDE	OFFSET	SIDE	OFFSET	SIDE	OFFSET	SIDE	OFFSET	SIDE	OFFSET	SIDE	OFFSET
EVERFAIR CRESCENT (LOTS 418-426 & 401)	EAST	2.10m	EAST	2.50m	EAST	3.10m	WEST	1.00m	WEST	2.60m	WEST	1.80m (EXISTING)
TARKINE STREET	EAST	2.10m	EAST	2.50m	EAST	3.10m	WEST	1.00m	WEST	2.60m	WEST	1.80m (EXISTING)
EVERFAIR CRESCENT (LOTS 412-418 & 434-437)	NORTH	2.10m	NORTH	2.50m	NORTH	3.10m	SOUTH	1.80m	SOUTH	2.60m	NORTH SOUTH	1.00m 1.00m
CLEARFELL STREET (LOTS 403-412)	WEST	2.10m	WEST	2.50m	WEST	3.10m	EAST	1.80m	EAST	2.60m	WEST	1.00m
CLEARFELL STREET (LOTS 401-403)	SOUTH	1.95m	SOUTH	2.35m	SOUTH	2.95m	NORTH	1.00m	NORTH	0.50m	-	-
KIELDER STREET	EAST	2.10m	EAST	2.50m	EAST	3.10m	WEST	1.80m	WEST	2.60m	-	-
SAWMILLER STREET	EAST	2.10m	EAST	2.50m	EAST	3.10m	WEST	1.80m	WEST	2.60m	WEST	1.00m
GONDWANA STREET	EAST	2.10m	EAST	2.50m	EAST	3.10m	WEST	1.80m	WEST	2.60m	-	-
ADDI EDIJOLI WALIK	OOUTU	4.05	OOUTU	0.05	COLUTIA	0.75	COLITII	0.05	COLUTIA	0.75		

WARNING

BEWARE OF UNDERGROUND SERVICES

THE LOCATIONS OF UNDERGROUND SERVICES ARE APPROXIMATE ONLY AND THEIR EXACT POSITION SHOULD BE PROVED ON SITE NO GUARANTEE IS GIVEN THAT ALL EXISTING SERVICES ARE SHOWN A MOCS ENOURRY ON 1100 MUST BE MADE BY THE CONTRACTOR PRIOR TO COMMENCEMENT OF WORKS.

WARNING

IT IS THE RESPONSIBILITY OF THE CONTRACTOR TO VERIFY THE SETOUT INFORMATION PROVIDED ON THIS PLAN WITH THE DESIGN INTENT WHICH INCLUDES BUT IS NOT LIMITED TO ITEMS. SUCH AS LENGTHS, CO-ORDINATES, SETOUT DIMENSIONS AND PEGGED TITLES BY THE PRINCIPAL'S LICENSED SURVEYOR.



CONSTRUCTION ISSUED FOR CONSTRUCTION

0	20/08/2021	ISSUED FOR CONSTRUCTION - CONTRACTOR	EST
VER	DATE	REVISION	APPD.
		-	

hillstowe DESIGNED: LOD

Coords: MGA

Levels: AHD CHECKED:


T4YLORS


AUTHORISED: JOY DRAFTED: WGO AUTH. DATE: 18/09/2020 CAD REF:


CARDINIA SHIRE COUNCIL 415 PRINCES HIGHWAY, OFFICER VIC 3809

HILLSTOWE ESTATE, STAGE 4 GENERAL NOTES, LOCALITY PLAN, DRAWING INDEX & SERVICE OFFSET TABLE


SCALE AS SHOWN @ A1 VERSION SHEET 1 OF DRAWING No

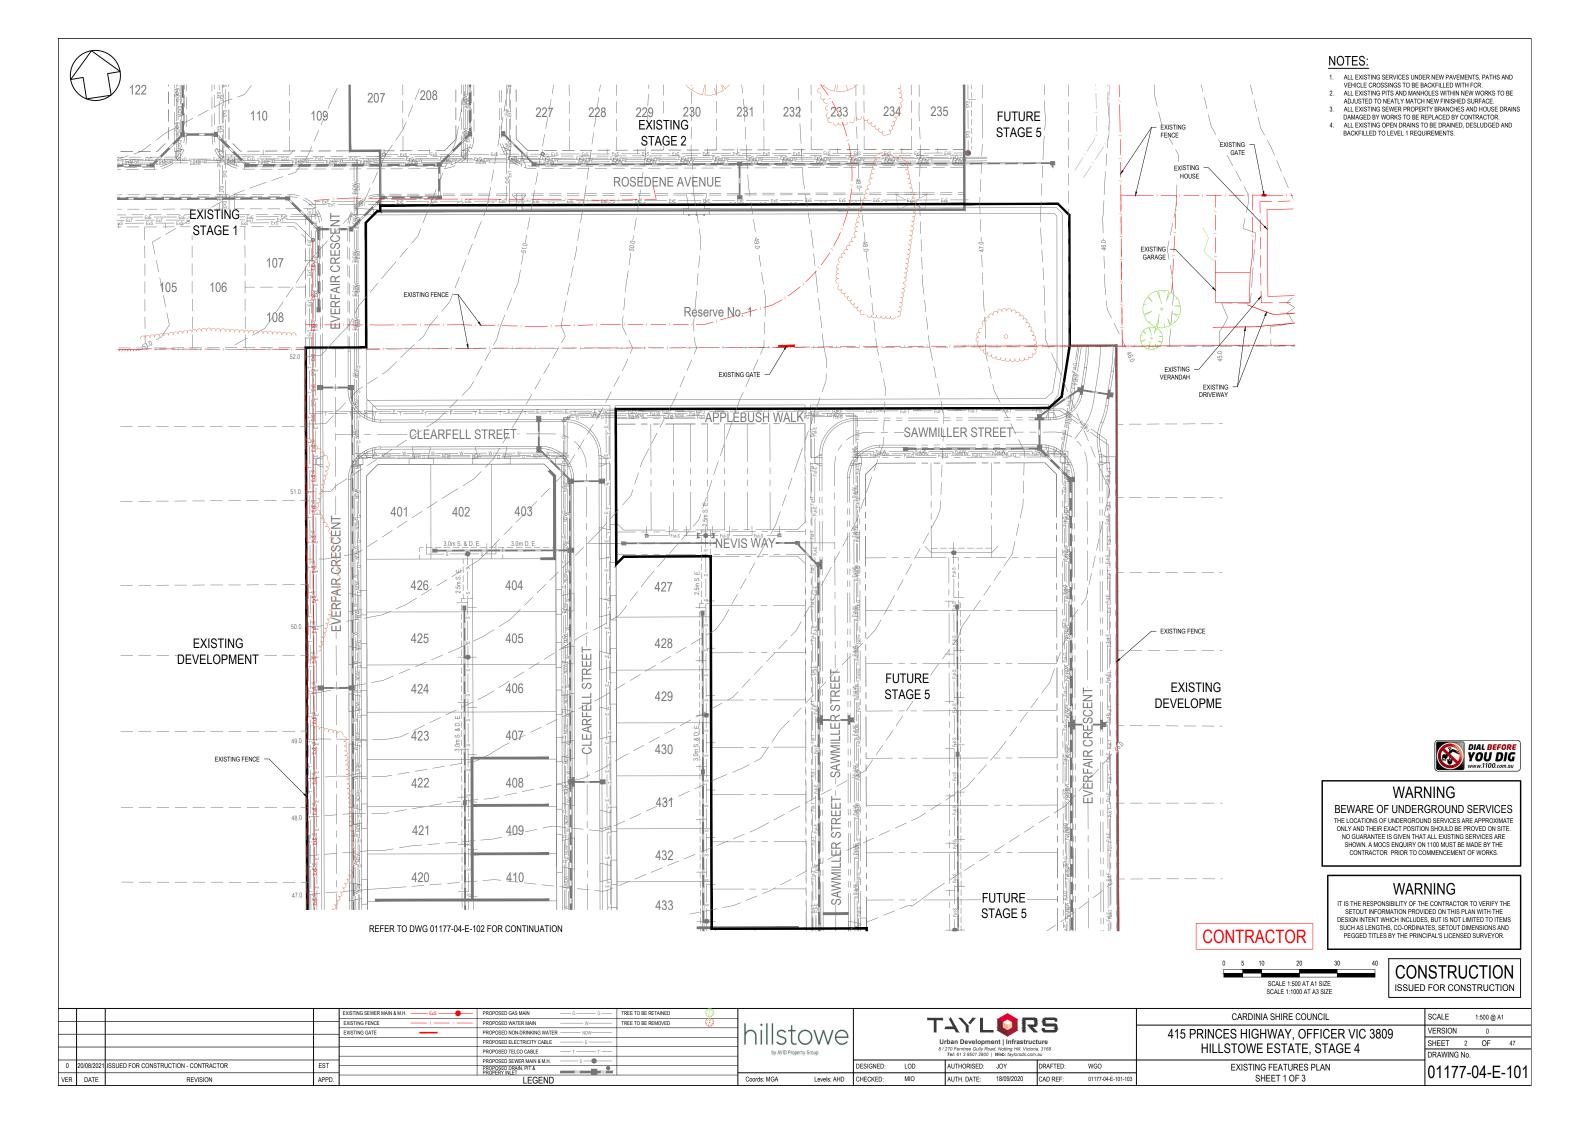


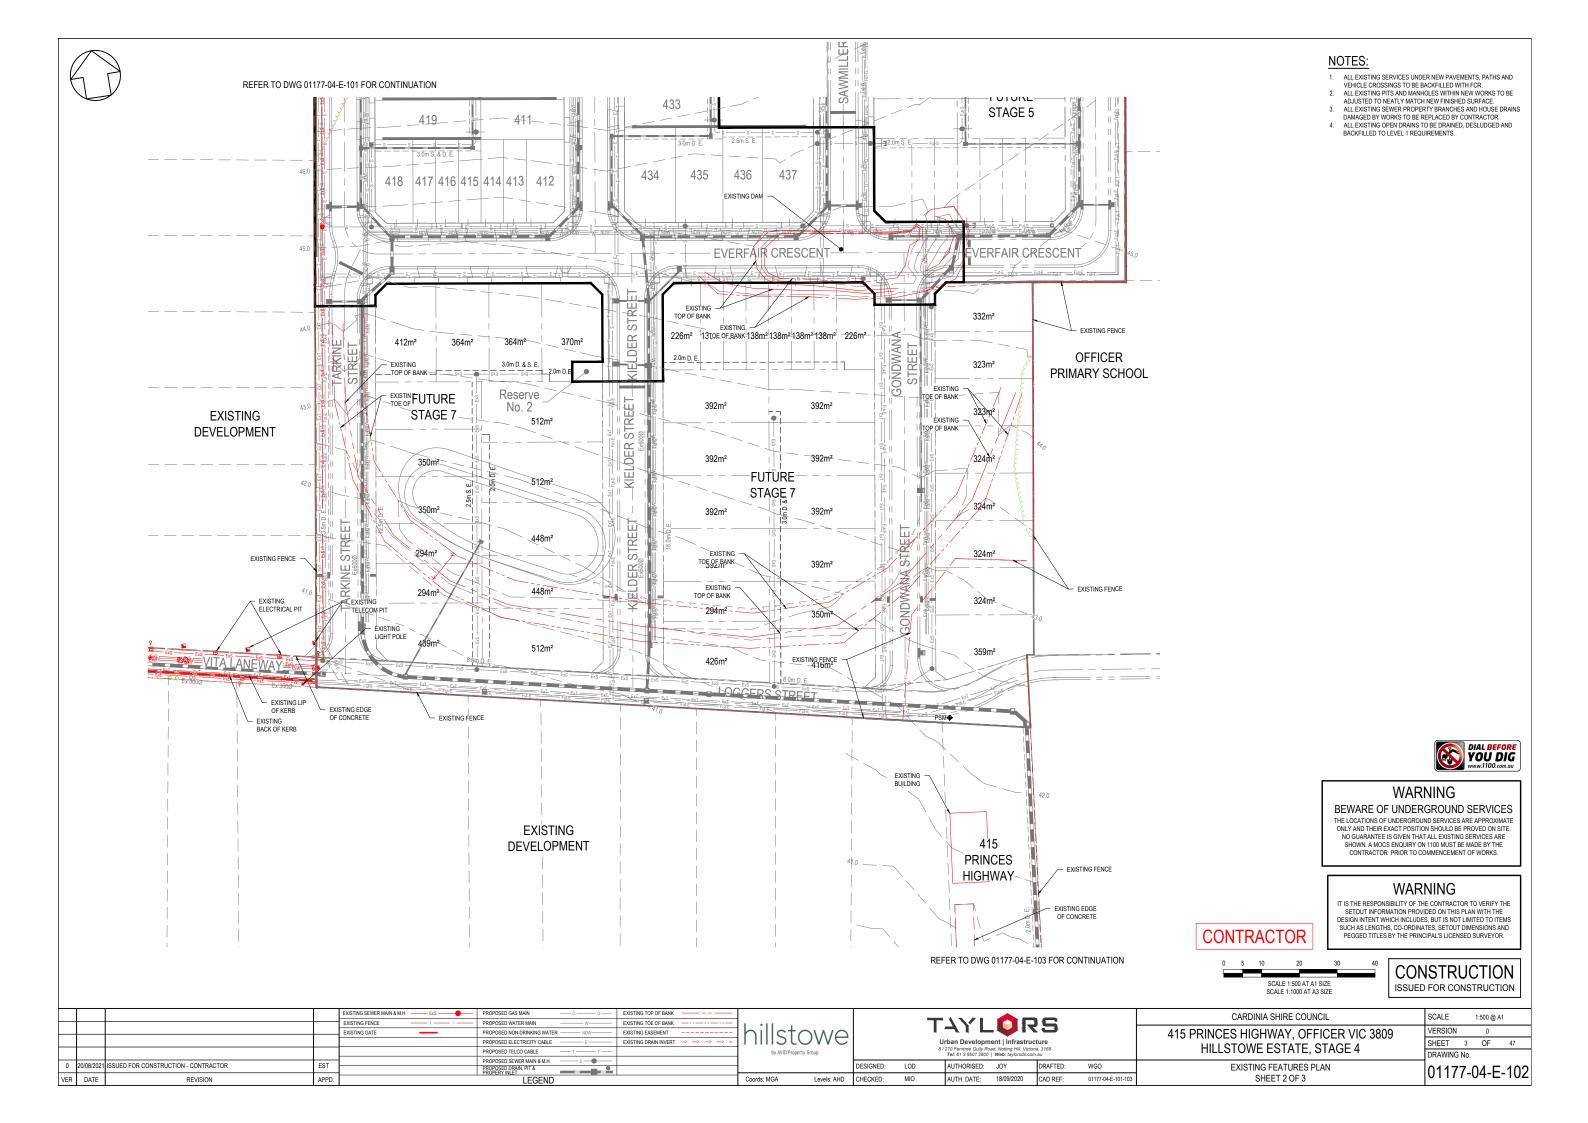

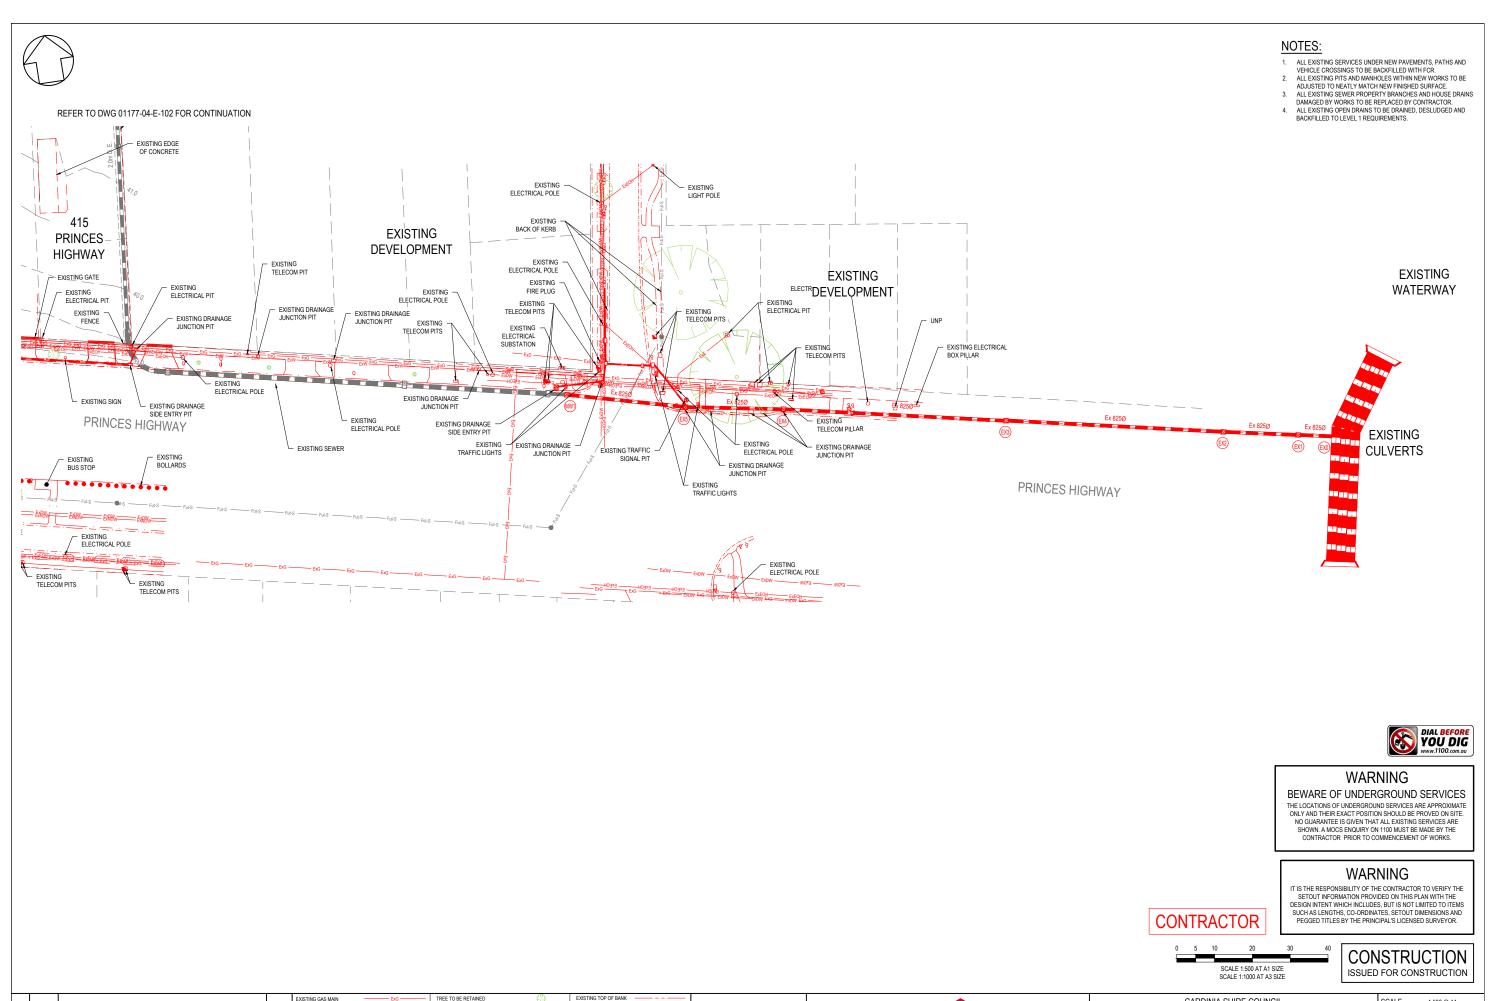

EXISTING ELECTRICITY CABLE ESC POLC DE EXISTING FENDE / Unban Development Infrastructure Urban Development Urban Development Infrastructure Urban Development Urban Develo	01177-04-L-	SHEET 3 OF 3	Levels: AHD CHECKED: MIO AUTH. DATE: 18/09/2020 CAD REF: 01177-04-E-101-103		Coords: MGA Levels:	LEGEND			APPD.	N	REVISION	DATE	VER							
EXISTING ELECTRICITY CABLE EXE POLE E EXISTING FENCE	01177-04-E- ⁻		WGO	DKAFTED:	Y	JRISED: JO	AUTH	LOD	DESIGNE			_		EXISTING LIP OF KERB	EXISTING OVERHEAD CABLE EXECH	ESI	ACTUR	IZ I I I SOUED FOR CONSTRUCTION - CONTRA	20/08/202	0
EXISTING ELECTRICITY CABLE — EXE — POLE & EXISTING FENCE — EXISTING EDGG OF FENCE — EXISTING EDG		EVICTING FEATURES BLAN	woo	DDAFTED	v I	ODIOED I	Laure	1.00	DEGIONE			PROPOSED DRAIN & PIT		EXISTING BACK OF KERB	EXISTING DRAIN EXD ———	FCT	ACTOR	104 ICCUED FOR CONCERNICATION CONTRA	20/00/202	
EXISTING PRINCES HIGHWAY, OFFICER VIC 3809	DRAWING No.	MILLSTOWE ESTATE, STAGE 4					by AVID Property Group	δ <u>Δ</u>	EXISTING SIGN		EXISTING EDGE OF FORMATION	EXISTING SEWER MAIN & M.H. EXS								
EXISTING ELECTRICITY CABLE — DIE — POLE ♦ E EXISTING FRANCE — / — / — EXISTING DRAN INVERT → → → -			Urban Development Intrastructure					_	EXISTING GATE		EXISTING EDGE OF BITUMEN	EXISTING TELCO CABLE & PIT EXT	E							
	R VIC 3809 VERSION 0	415 PRINCES HIGHWAY, OFFICER VIC 3809			415 PRINCES HIGHWAY OFFICER VIC 38		\rightarrow \rightarrow \rightarrow $-$	EXISTING DRAIN INVERT		EXISTING FENCE	EXISTING ELECTRICITY CABLE -EXE -POLE C E	E				\vdash				
CARDINIA SHIRE COUNCIL	SCALE 1:500 @ A1			5		\checkmark	Τ7,			1 *11 - 1		EXISTING TOE OF BANK	()	TREE TO BE REMOVED	EXISTING WATER MAIN EXW	1			†	\vdash

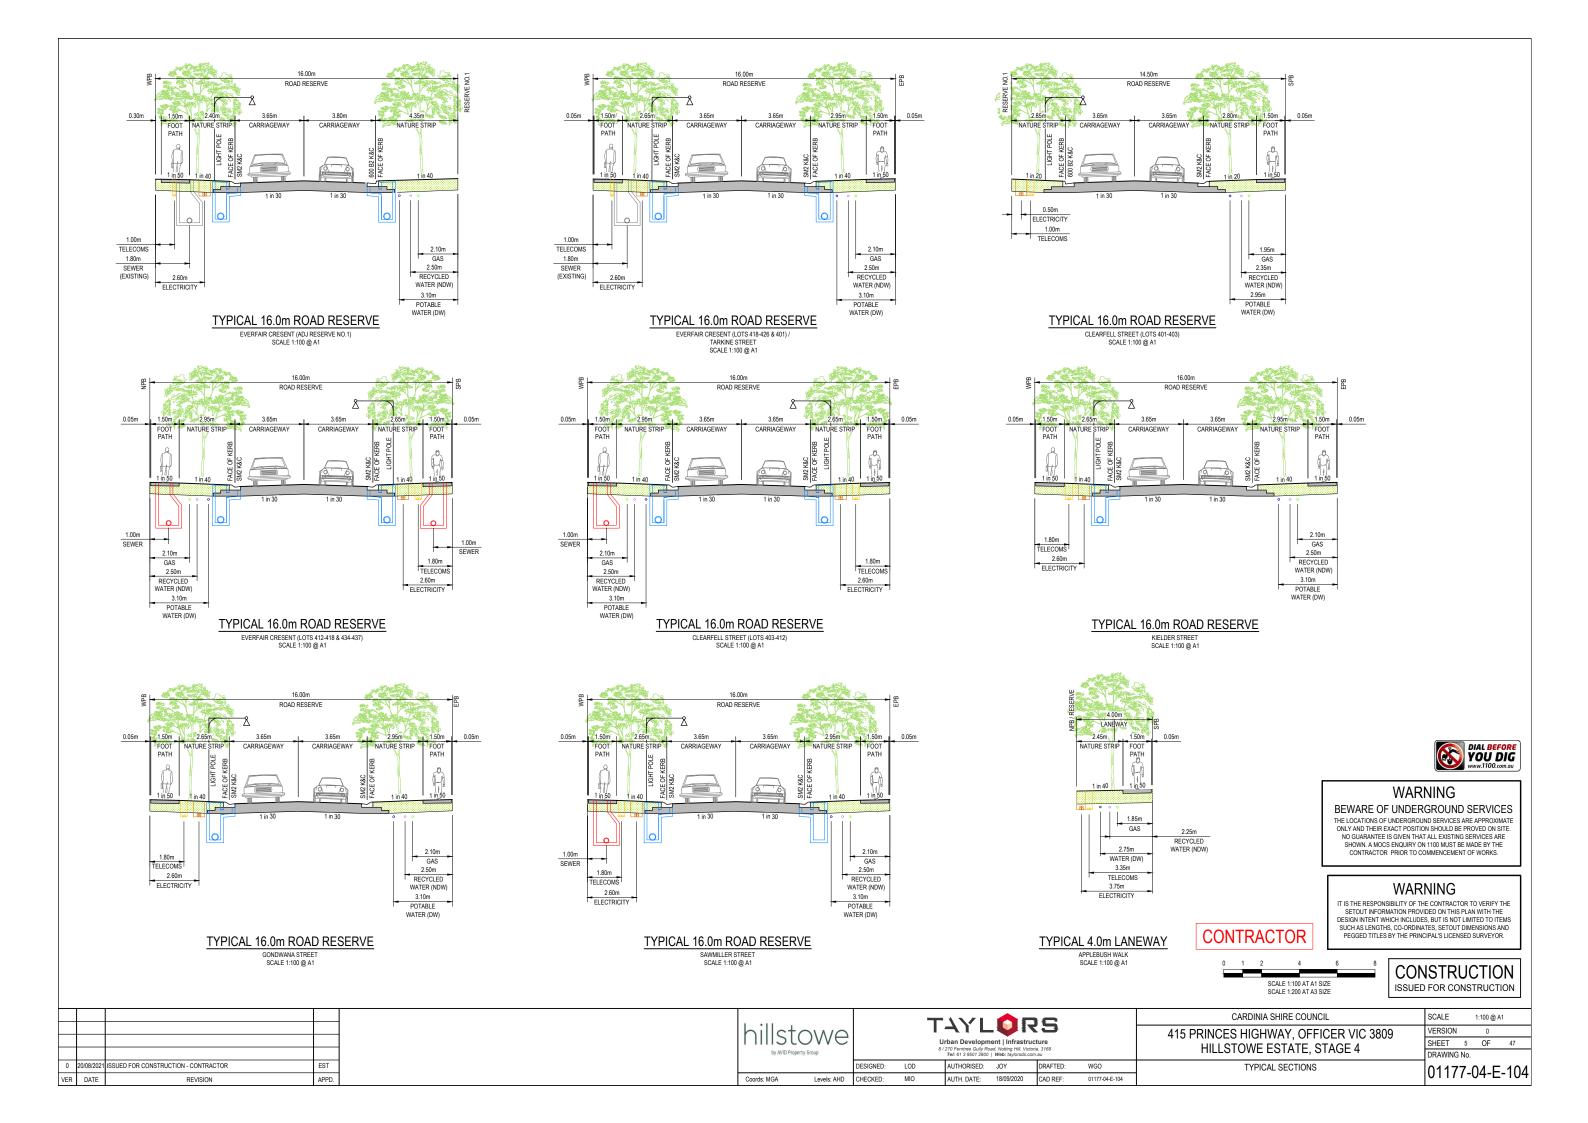

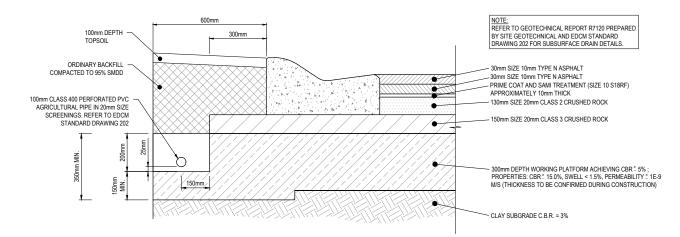



ACCESS STREET LEVEL 1 - OVER EXPANSIVE SUBGRADE

EVERFAIR CRESCENT, CLEARFELL STREET, KIELDER STREET, SAWMILLER STREET, GONDWANA STREET, TARKINE STREET, DEERLODGE STREET -650mm PAVEMENT COMPOSITION DETAIL

PAVEMENT DETAIL NOTE:

- THE PAVEMENT DESIGNS SHOWN HAVE BEEN DESIGNED & PROVIDED BY SITE GEOTECHNICAL WHO ARE RESPONSIBLE FOR THE GEOTECHNICAL WORK ON THIS PROJECT.
- THE PAVEMENT DESIGNS SHOWN HAVE BEEN DESIGNED & PROVIDED BY SITE GEOTECHNICAL WHO ARE RESPONSIBLE FOR THE GEOTECHNICAL WORK ON THIS PROJECT TAYLORS IS NOT RESPONSIBLE FOR THE WORK OF SITE GEOTECHNICAL TAYLORS IS NOT RESPONSIBLE FOR THE WORK OF SITE GEOTECHNICAL REPORT "PRELIMINARY GEOTECHNICAL INVESTIGATION & PAVEMENT DESIGN & PRELIMINARY SOIL CLASSIFICATION REPORT FOR SLABS AND FOOTING CONSTRUCTION".
 THIS DOCUMENT SHOULD BE REVIEWED TO ENSURE THAT THE DESIGN HAS BEEN ACCURATELY REPRODUCED.
 TAYLORS DOES NOT ACCEPT ANY RESPONSIBILITY FOR THE ACCURACY, ADEQUACY OR APPROPRIATENESS OF THE GEOTECHNICAL WORK AND/OR PAVEMENT DESIGNS.
 ANY QUERIES SHOULD BE ADDRESSED TO SITE GEOTECHNICAL AND SENT TO TAYLORS.

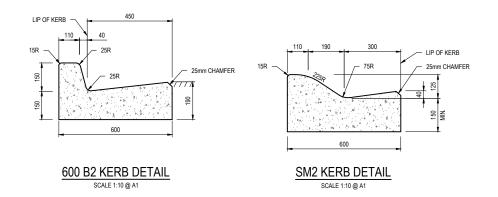


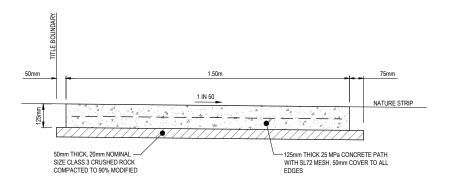


TYPICAL RESIDENTIAL FOOTPATH DETAIL

SCALE 1:10 @ A1 (REFER TO EDCM STANDARD DWG 401)


FOOTPATH DETAIL NOTE:
FOOTPATH CONSTRUCTED IN FILL SHALL BE USING STRUCTURAL FILL MATERIAL TO BE APPROVED TYPE "A" MATERIAL AS PER VICROADS SERIES 200 DOCUMENT TABLE 204.04. SPREAD IN SUCCESSIVE LAYERS NOT EXCEEDING 150mm (LOOSE MEASUREMENT) AND COMPACTED THROUGHOUT TO A DRY DENSITY OF NOT LESS THAN 38% STANDARD COMPACTION

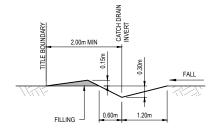


TYPICAL CATCH DRAIN SECTION

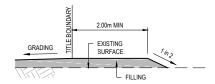

STAGE BOUNDARY LOT FILLING

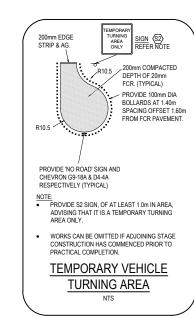

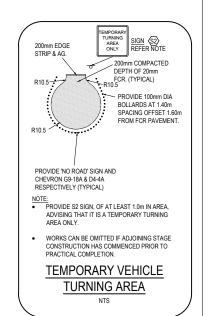



WARNING

BEWARE OF UNDERGROUND SERVICES

THE LOCATIONS OF UNDERGROUND SERVICES ARE APPROXIMATE ONLY AND THEIR EXACT POSITION SHOULD BE PROVED ON SITE. NO GUARANTEE IS GIVEN THAT ALL EXISTING SERVICES ARE SHOWN A MOCS ENQUIRY ON 1100 MUST BE MADE BY THE CONTRACTOR PRIOR TO COMMENCEMENT OF WORKS.

WARNING

IT IS THE RESPONSIBILITY OF THE CONTRACTOR TO VERIFY THE SETOUT INFORMATION PROVIDED ON THIS PLAN WITH THE DESIGN INTENT WHICH INCLUDES BUT IS NOT LIMITED TO ITEMS SUCH AS LENGTHS. CO-ORDINATES. SETOUT DIMENSIONS AND PEGGED TITLES BY THE PRINCIPAL'S LICENSED SURVEYOR.



WGO

CAD REF:



CONSTRUCTION ISSUED FOR CONSTRUCTION

				l
]
]
				1
0	20/08/2021	ISSUED FOR CONSTRUCTION - CONTRACTOR	EST	1
VER	DATE	REVISION	APPD.	



ban Developme 270 Ferntree Gully Roa Tel: 61 3 9501 2800	d, Notting Hill, Victoria	a, 3168
AUTHORISED:	JOY	DRAFTED:

AUTH. DATE: 18/09/2020


CARDINIA SHIRE COUNCIL 415 PRINCES HIGHWAY, OFFICER VIC 3809 HILLSTOWE ESTATE. STAGE 4

CONTRACTOR


SCALE AS SHOWN @ A1 VERSION SHEET 6 OF 47 DRAWING No


TYPICAL DETAILS




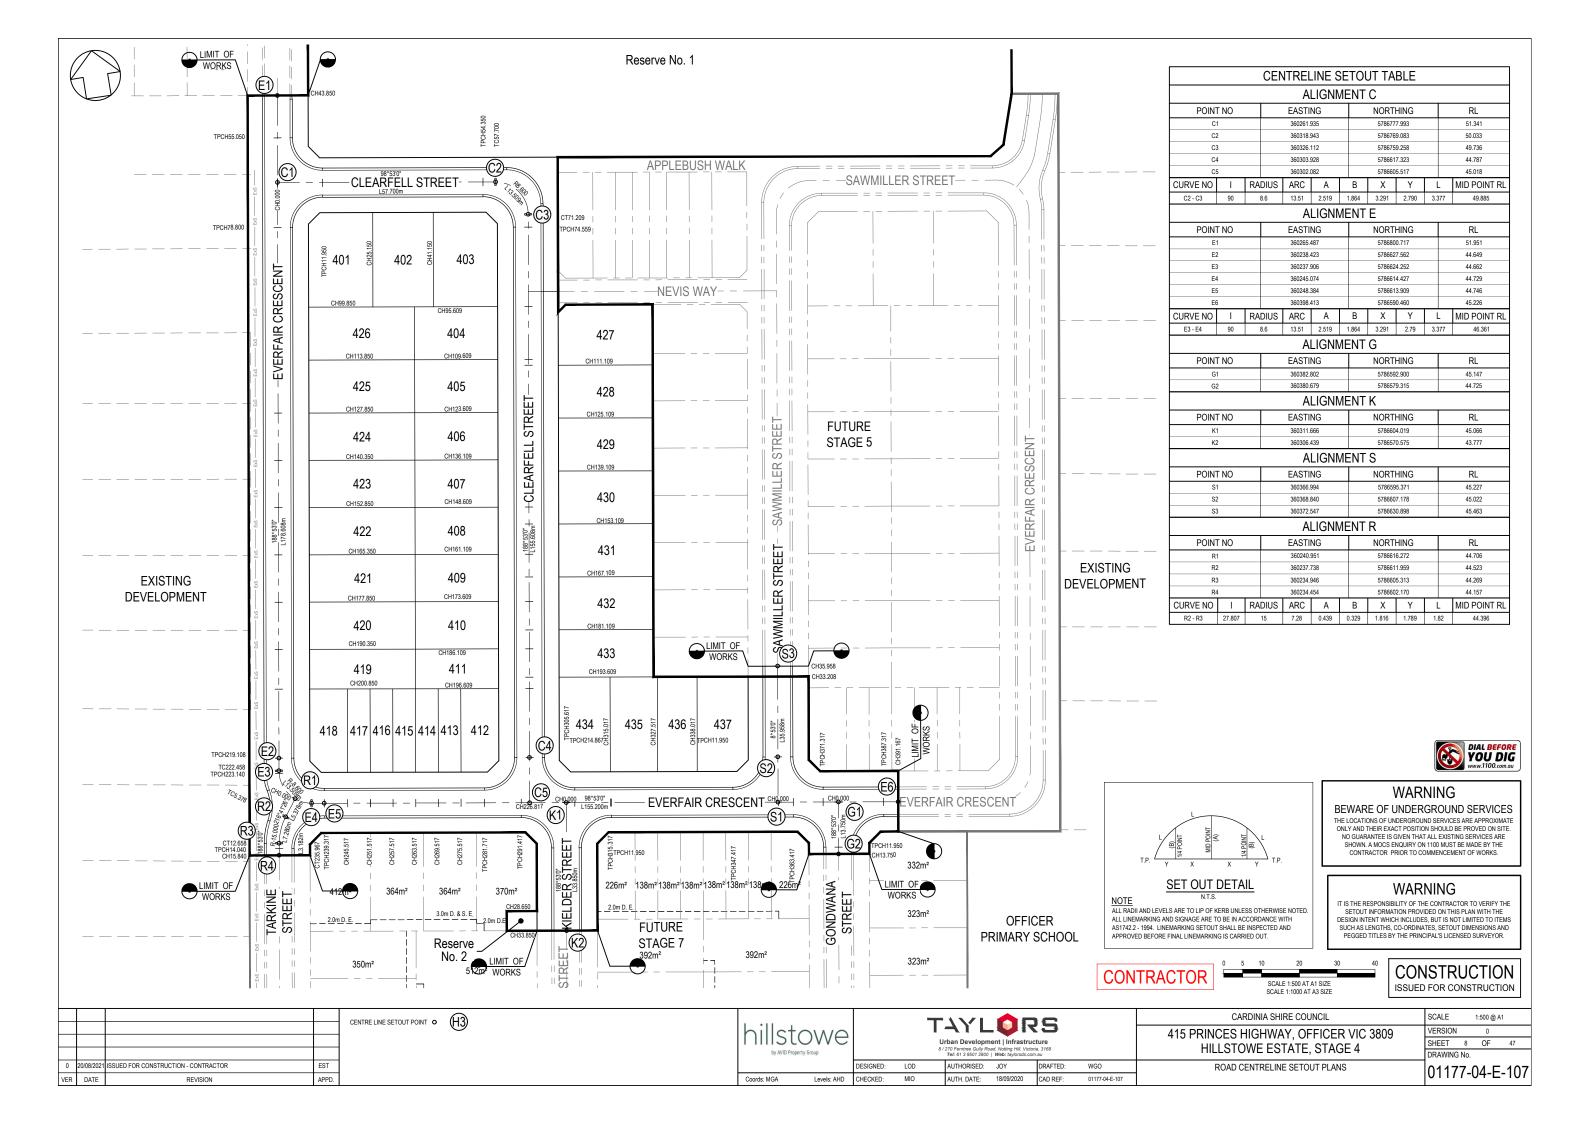



	JF St	JBDIVISIO	N		EDITIO	ON 1	PS83	9251V			
LOCATION	OF LAN	ND			COUNCIL N	AME: CAF	RDINIA SHIRE COI	UNCIL			
PARISH: TOWNSHIP: SECTION:		PAKENHA	M								
CROWN ALLO		39A (PART) & 39	B (PART)								
TITLE REFERE	Vol. 12267 Fol.	927									
LAST PLAN RE	EFERENC	E: Lot C on PS8360	44S								
POSTAL ADDR (at time of subdivis		46 - 50 Bayview F OFFICER 3809	Road								
MGA 94 CO-Ol (of approx centre c land in plan)	RDINATES of	S: E: 360 290 N: 5786 690	ZONE:	55							
		ROADS AND/OF		s			NOTATIONS	3			
IDENTIFIER			BODY/PERSON		Lots 401 to 437	(both inclusi	e) may be affected by	one or more restrictions.			
Road R1 Reserve No Reserve No	0.1	Cardinia : Cardinia : Ausnet Electric	Shire Council Shire Council ity Services Pt	y Ltd	OTHER PURP Removal of the	OSE OF PLA	v v	s 5 & 6 of this plan for details. PS838044S in so far as where on of this plan.			
		NOTATIONS			1						
DEPTH LIMITATIO	ON: Does	s Not Apply			GROUNDS FOR REMOVAL: By agreement between all interested parties vide Sec.8(1)(k) of the Subdivision Act 1988.						
SURVEY: This plan is based STAGING: This is not a stage		n.									
This plan is based STAGING: This is not a stage This survey has be in Proclaimed Surv HILLSTOW	een connecte vey Area No. E ESTAT	ed to Pakenham PM82 an . (Not Applicable) FE - Release No. 4		20							
This plan is based STAGING: This is not a stage This survey has be In Proclaimed Surv	een connects vey Area No. /E ESTAT ase: 3.11	ed to Pakenham PM82 an (Not Applicable)	1 5 H & Y								
This plan is based STAGING: This is not a stage This survey has be in Proclaimed Sun HILLSTOW Area of Relea No. of Lots:	een connects wey Area No. E ESTAT ase: 3.11 37 L	ed to Pakenham PM82 an (Not Applicable) IE - Release No. 4 14ha Lots and Balance Lot	; s Н & Y EA:	SEMENT I	NFORMATIC						
This plan is based STAGING: This is not a stage This survey has be in Proclaimed Sun HILLSTOW Area of Relea No. of Lots:	een connects wey Area No. E ESTAT ase: 3.11 37 L	ed to Pakenham PM82 an (Not Applicable) FE - Release No. 4 14ha	; s Н & Y EA:	SEMENT I							
This plan is based STAGING: This is not a stage This survey has be in Proclaimed Sun HILLSTOW Area of Relea No. of Lots: LEGEND: A - Ap Easement Reference	een connecte wey Area No. "E ESTAT ase: 3,7 L appurtenant E	ed to Pakenham PM82 an (Net Applicable) TE - Release No. 4 14ha Lots and Balance Lots asement E-Encumber	EA: The second of the second	SEMENT III	ng Easement (Ros Irigin		Land Benefitor				
This plan is based STAGING: This is not a stage This survey has be In Proclaimed Sun HILLSTOW Area of Relea No. of Lots: LEGEND: A - Ap Easement Reference E-1	een connecte wey Area No. "E ESTAT ase: 37 L appurtenant E	ed to Pakenham PM82 an (Not Applicable) FE - Release No. 4 Haha Lots and Balance Lot assement E-Encumber Purpose	EA: Width (Metres) 3.50	SEMENT II R - Encumberii	ng Easement (Roo Prigin 26731D		South East Wa	ter Corporation			
This plan is based STAGING: This is not a stage This survey has be in Proclaimed Sun HILLSTOW Area of Relea No. of Lots: LEGEND: A - Ap Easement Reference	een connecte	ed to Pakenham PM82 an (Net Applicable) TE - Release No. 4 14ha Lots and Balance Lots asement E-Encumber	EA: The second of the second	SEMENT III	ng Easement (Ros Irigin			ter Corporation ter Corporation			
This plan is based STAGING: This is not a stage This is not a stage In Proclaimed Sun HILLSTOW Area of Relea No. of Lots: Easement Reference E-1 E-2 E-2	een connecte een c	nd to Pakenham PM82 and (Not Applicable) FE - Release No. 4 14ha Lots and Balance Lob assement E - Encumber Purpose swerage	EA: ing Easement Width (Metres) 3.50	SEMENT IN R - Encumberia O PS82 PS83 This	ng Easement (Ros Prigin 26731D 36044S		South East Wa South East Wa South East Wa Cardinia Sh	ter Corporation ter Corporation ter Corporation ire Council			
This plan is based STAGING: STAGING: This is not a stage This survey has be in Proclaimed Survey HILLSTOW Area of Relea No. of Lots: LEGEND: A - AF Easement Reference E-1 E-2 E-3	een connecte een c	sed to Pakenham PM82 and (Not Applicable) [TE - Release No. 4 14ha Lots and Balance Lot assement	EA: ing Easement Width (Metres) 3.50 2 See Diag.	SEMENT III R - Encumberia O PS82 PS83 This	ng Easement (Ros Prigin 26731D 36044S s Plan		South East Wa South East Wa South East Wa Cardinia Sh South East Wa	ter Corporation ter Corporation ter Corporation irre Council ter Corporation			
This pain is based STAGING: STAGING: This survey has be in Procialmed Survey has been proceeded in Procial Survey has been proceeded in Proceeding Survey has been proceeded in Procial Survey has been proceeded in Proceeding Su	een connecte een c	und to Pakenham PM82 and (Not Applicable) TE - Release No. 4 14ha Lots and Balance Lots and	EAST SEEDING EAST SEEDING.	SEMENT III R - Encumberia O PS82 PS83 This	ng Easement (Ros Prigin 26731D 36044S s Plan s Plan		South East Wa South East Wa South East Wa Cardinia Sh	ter Corporation ter Corporation ter Corporation irre Council ter Corporation			
This pain is based STAGING: STAGING: This survey has be in Procialmed Survey has been proceeded in Procial Survey has been proceeded in Proceeding Survey has been proceeded in Procial Survey has been proceeded in Proceeding Su	een connecte een c	sed to Pakenham PM82 and (Not Applicable) [TE - Release No. 4 14ha Lots and Balance Lot assement	EAST SEEDING EAST SEEDING.	SEMENT III R - Encumberia O PS82 PS83 This	ng Easement (Ros Prigin 26731D 36044S s Plan s Plan		South East Wa South East Wa South East Wa Cardinia Sh South East Wa	ter Corporation ter Corporation ter Corporation irre Council ter Corporation			
This pain is based STAGING: STAGING: This survey has be in Procialmed Survey has been proceeded in Procial Survey has been proceeded in Proceeding Survey has been proceeded in Procial Survey has been proceeded in Proceeding Su	een connecte een c	sed to Pakenham PM82 and (Not Applicable) [TE - Release No. 4 14ha Lots and Balance Lot assement	EA: ing Easement Width (Metres) 3.50 2 See Diag. See Diag.	SEMENT II R - Encumberia O PS84 PS85 Third Third Third Third RS FILE REF:	ng Easement (Ros Prigin 26731D 36044S s Plan s Plan	ad)	South East Wa South East Wa South East Wa Cardinia Sh South East Wa	ter Corporation ter Corporation ter Corporation irre Council ter Corporation			

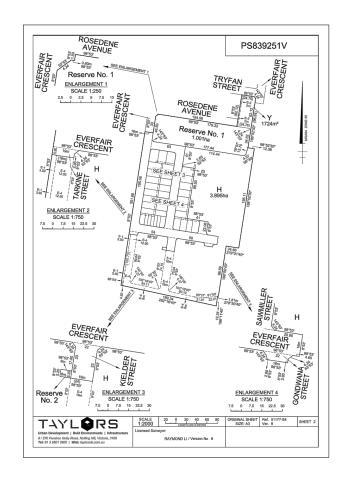

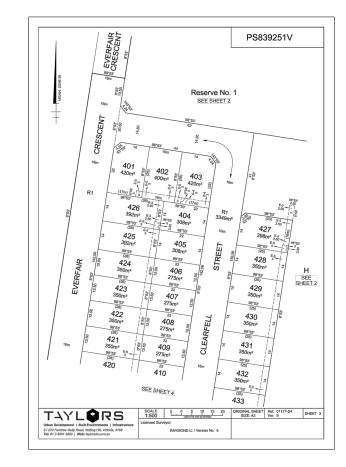

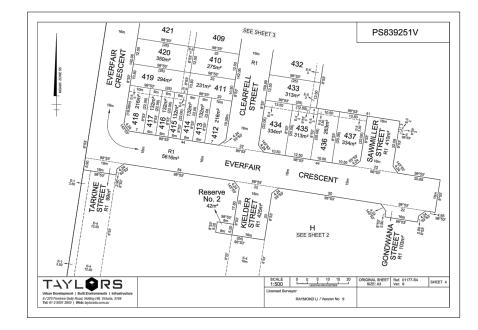

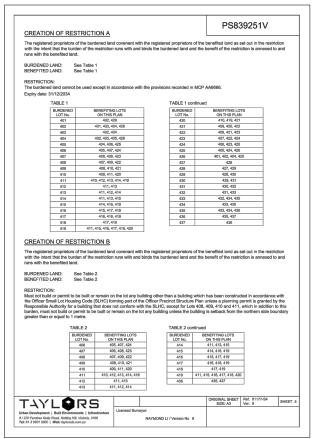

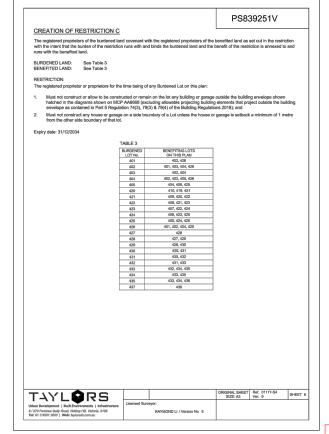



WARNING

BEWARE OF UNDERGROUND SERVICES

THE LOCATIONS OF UNDERGROUND SERVICES ARE APPROXIMATE ONLY AND THEIR EXACT POSITION SHOULD BE PROVED ON SITE. NO GUARANTEE IS GIVEN THAT ALL EXISTING SERVICES ARE SHOWN. A MOCS ENQUIRY ON 1100 MUST BE MADE BY THE CONTRACTOR PRIOR TO COMMENCEMENT OF WORKS.

WARNING

IT IS THE RESPONSIBILITY OF THE CONTRACTOR TO VERIFY THE SETOUT INFORMATION PROVIDED ON THIS PLAN WITH THE DESIGN INTENT WHICH INCLUDES, BUT IS NOT LIMITED TO ITEMS SUCH AS LENGTHS, CO-ORDINATES, SETOUT DIMENSIONS AND PEGGED TITLES BY THE PRINCIPAL'S LICENSED SURVEYOR.



CONSTRUCTION ISSUED FOR CONSTRUCTION

SCALE

0	20/08/2021	ISSUED FOR CONSTRUCTION - CONTRACTOR	EST	
VER	DATE	REVISION	APPD.	

hillstowe

Levels: AHD CHECKED:

Coords: MGA




AUTHORISED: JOY DRAFTED: WGO AUTH. DATE: 18/09/2020 CAD REF:


415 PRINCES HIGHWAY, OFFICER VIC 3809


VERSION SHEET 9 OF 47 HILLSTOWE ESTATE, STAGE 4 DRAWING No.


PLAN OF SUBDIVISION

CARDINIA SHIRE COUNCIL

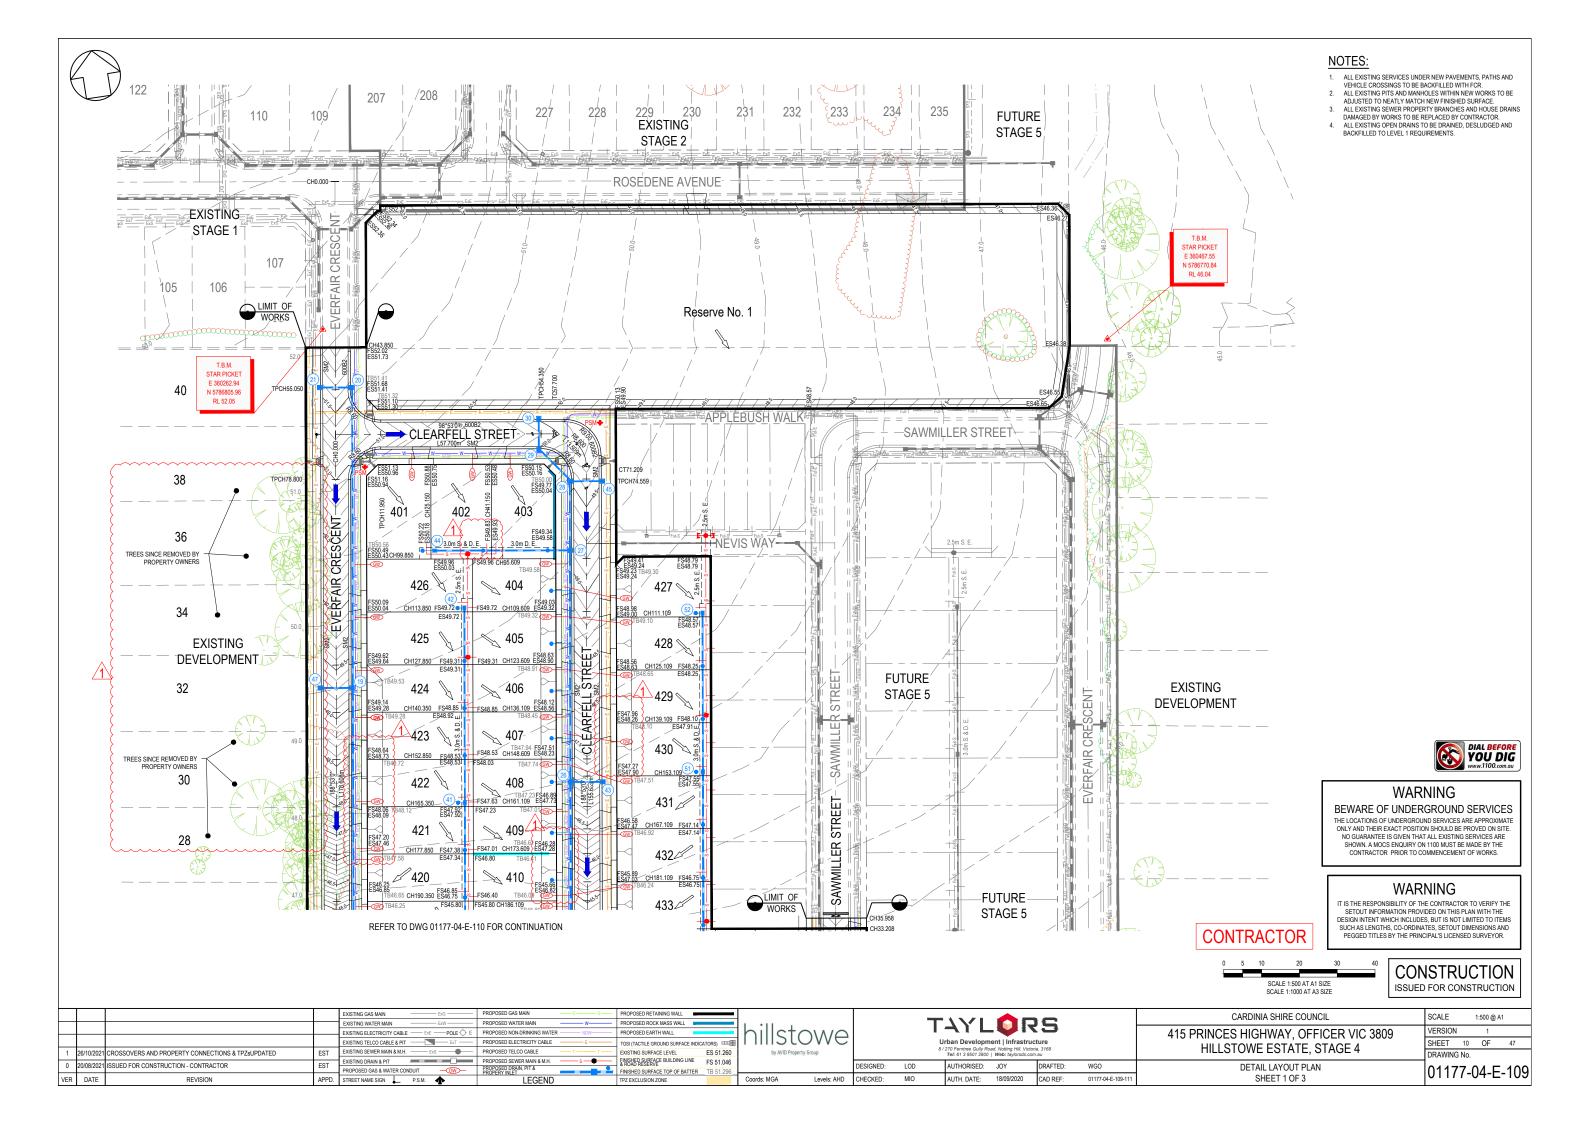

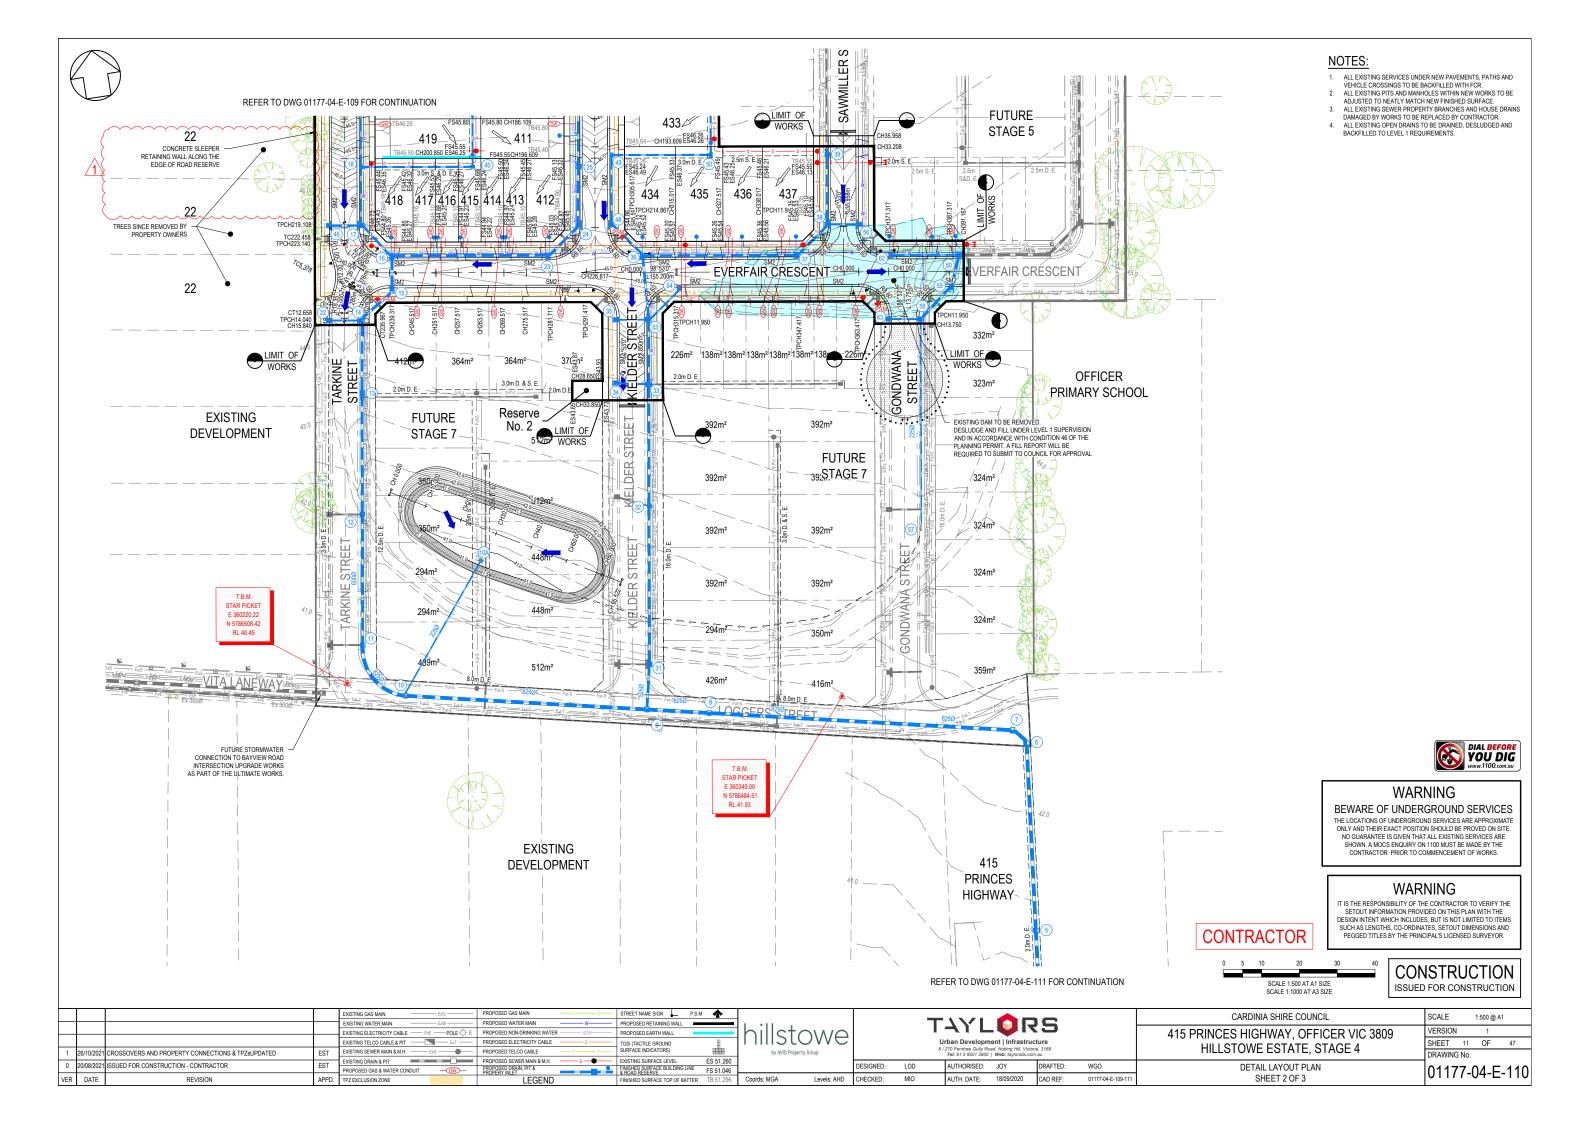

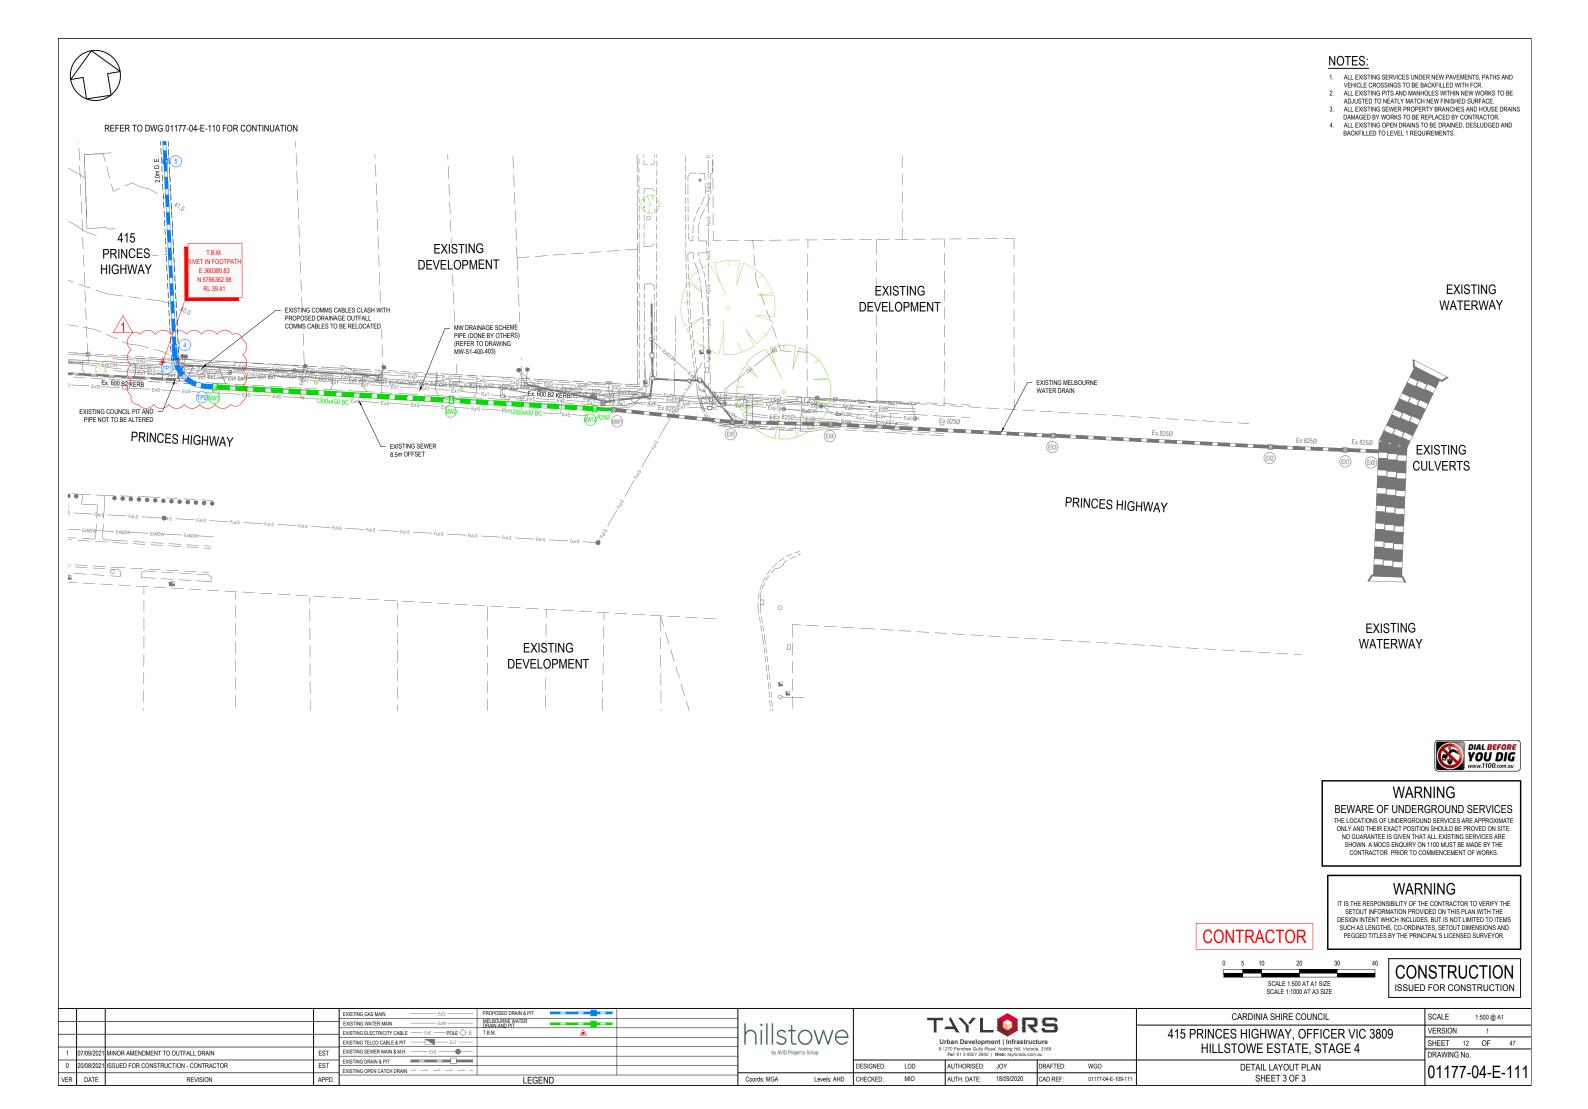

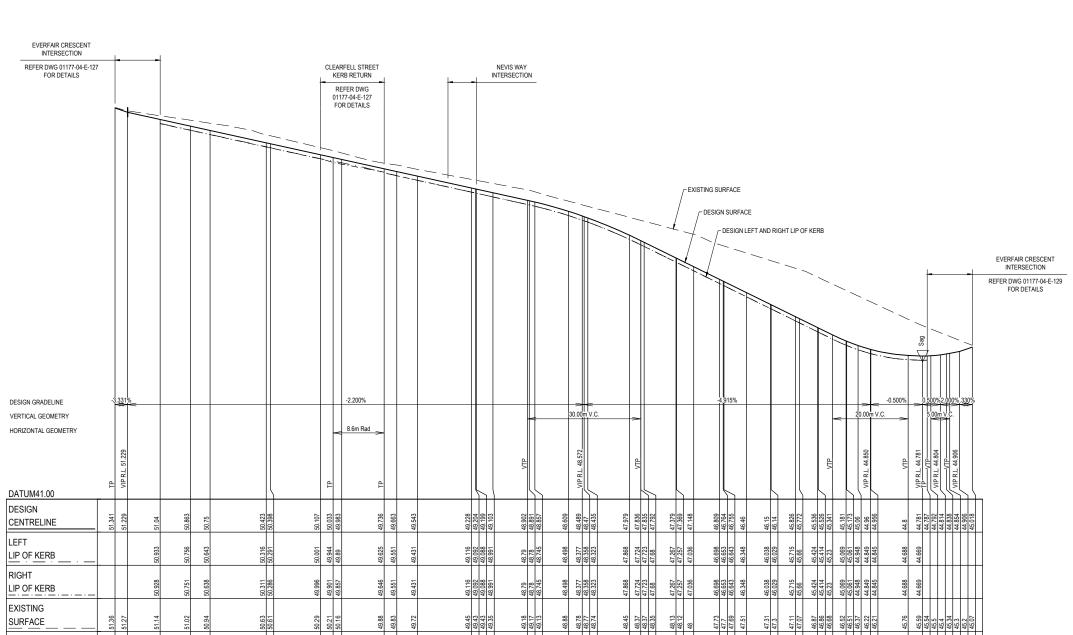

- ALL EXISTING SERVICES UNDER NEW PAVEMENTS, PATHS AND VEHICLE CROSSINGS TO BE BACKFILLED WITH FOR.

 ALL EXISTING PITS AND MANHOLES WITHIN NEW WORKS TO BE ADJUSTED TO NEATLY MATCH NEW FINISHED SUFFACE.

 ALL EXISTING SEWER PROPERTY BRANCHES AND HOUSE DRAINS DAMAGED BY WORKS TO BE REPLACED BY CONTRACTOR.

 ALL EXISTING OPEN DRAINS TO BE DRAINED, DESLUDGED AND BACKFILLED TO LEVEL 1 REQUIREMENTS.

CLEARFELL STREET



WARNING

BEWARE OF UNDERGROUND SERVICES

THE LOCATIONS OF UNDERGROUND SERVICES ARE APPROXIMATE ONLY AND THEIR EXACT POSITION SHOULD BE PROVED ON SITE. NO GUARANTEE IS GIVEN THAT ALL EXISTING SERVICES ARE SHOWN. A MOCS ENQUIRY ON 1100 MUST BE MADE BY THE CONTRACTOR PRIOR TO COMMENCEMENT OF WORKS.

WARNING

IT IS THE RESPONSIBILITY OF THE CONTRACTOR TO VERIFY THE SETOUT INFORMATION PROVIDED ON THIS PLAN WITH THE DESIGN INTENT WHICH INCLUDES, BUT IS NOT LIMITED TO ITEMS SUCH AS LENGTHS, CO-ORDINATES, SETOUT DIMENSIONS AND PEGGED TITLES BY THE PRINCIPAL'S LICENSED SURVEYOR.

CONSTRUCTION ISSUED FOR CONSTRUCTION

0	20/08/2021	ISSUED FOR CONSTRUCTION - CONTRACTOR	EST	
VER	DATE	REVISION	APPI	D.

CHAINAGE

hillstowe DESIGNED: LOD Coords: MGA Levels: AHD CHECKED:

T4YLORS AUTHORISED: JOY DRAFTED:

AUTH. DATE: 18/09/2020 CAD REF:

VERT

SCALE 1:500 AT A1 SIZE SCALE 1:1000 AT A3 SIZE 0 20

1 2 SCALE 1:50 AT A1 SIZE SCALE 1:100 AT A3 SIZE


WGO

CARDINIA SHIRE COUNCIL 415 PRINCES HIGHWAY, OFFICER VIC 3809 HILLSTOWE ESTATE, STAGE 4

CONTRACTOR

ROAD LONGITUDINAL SECTIONS SHEET 1 OF 5

SCALE	1:50	00 H, 1:50 \	/ @A1
VERSION		0	
SHEET	13	OF	47
DRAWING	No.		

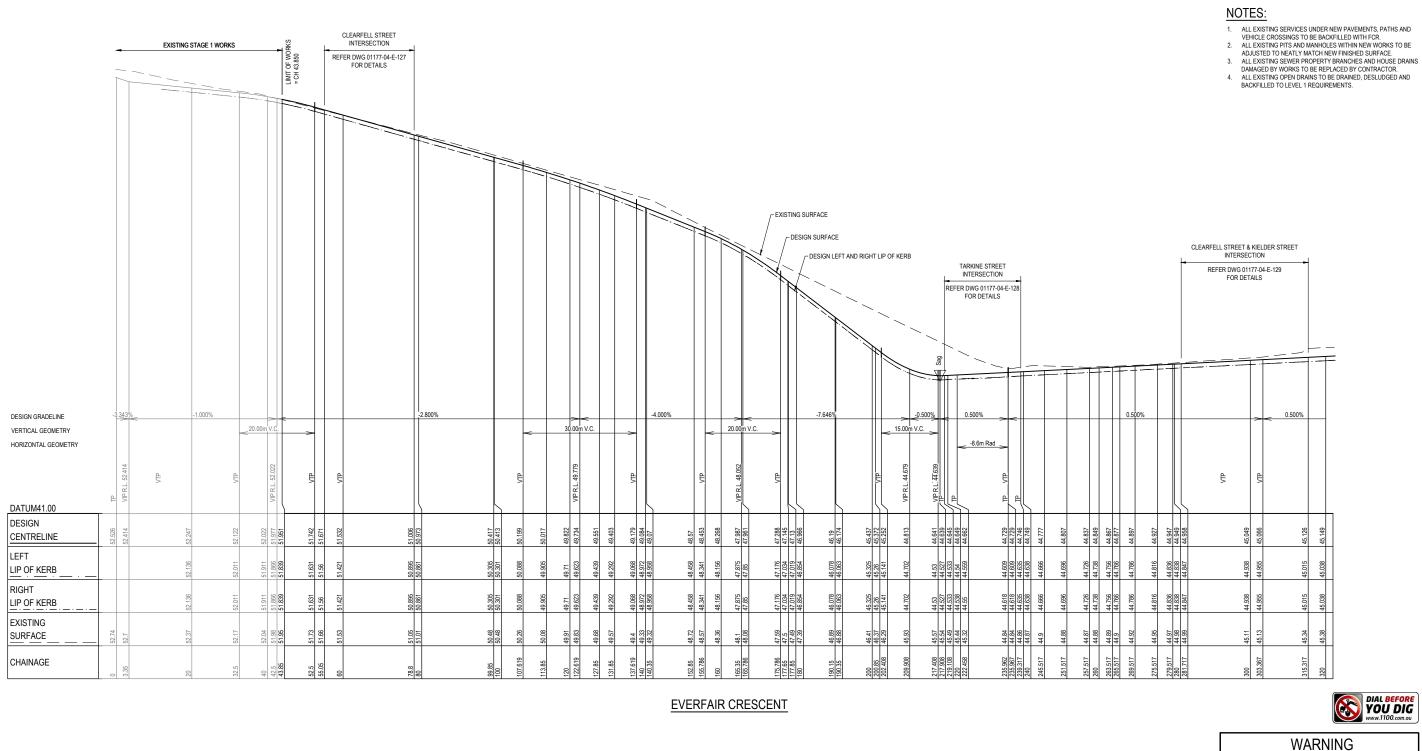

BEWARE OF UNDERGROUND SERVICES

THE LOCATIONS OF UNDERGROUND SERVICES ARE APPROXIMATE ONLY AND THEIR EXACT POSITION SHOULD BE PROVED ON SITE. NO GUARANTEE IS GIVEN THAT ALL EXISTING SERVICES ARE SHOWN. A MOCS ENQUIRY ON 1100 MUST BE MADE BY THE CONTRACTOR PRIOR TO COMMENCEMENT OF WORKS.

WARNING

IT IS THE RESPONSIBILITY OF THE CONTRACTOR TO VERIFY THE SETOUT INFORMATION PROVIDED ON THIS PLAN WITH THE DESIGN INTENT WHICH INCLUDES, BUT IS NOT LIMITED TO ITEMS SUCH AS LENGTHS, CO-ORDINATES, SETOUT DIMENSIONS AND PEGGED TITLES BY THE PRINCIPAL'S LICENSED SURVEYOR.

CONSTRUCTION

ISSUED FOR CONSTRUCTION

0 20/08/2021 ISSUED FOR CONSTRUCTION - CONTRACTOR EST VER DATE APPD. REVISION

hillstowe Coords: MGA Levels: AHD CHECKED:

T4YLORS Urban Development | Infrastructure DESIGNED: LOD AUTHORISED: JOY DRAFTED:

AUTH. DATE: 18/09/2020 CAD REF:

HORIZ

VERT

SCALE 1:500 AT A1 SIZE SCALE 1:1000 AT A3 SIZE

2 SCALE 1:50 AT A1 SIZE SCALE 1:100 AT A3 SIZE

WGO

CARDINIA SHIRE COUNCIL 415 PRINCES HIGHWAY, OFFICER VIC 3809 HILLSTOWE ESTATE, STAGE 4

CONTRACTOR

SCALE 1:500 H, 1:50 V @A1 VERSION SHEET 14 OF 47 DRAWING No.


ROAD LONGITUDINAL SECTIONS SHEET 2 OF 5

- ALL EXISTING SERVICES UNDER NEW PAVEMENTS, PATHS AND VEHICLE CROSSINGS TO BE BACKFILLED WITH FCR.

 ALL EXISTING PITS AND MANHOLES WITHIN NEW WORKS TO BE ADJUSTED TO NEATLY MATCH NEW FINISHED SUFFACE.

 ALL EXISTING SEWER PROPERTY BRANCHES AND HOUSE DRAINS DAMAGED BY WORKS TO BE REPLACED BY CONTRACTOR.

 ALL EXISTING OPEN DRAINS TO BE DRAINED, DESLUDGED AND BACKFILLED TO LEVEL 1 REQUIREMENTS.

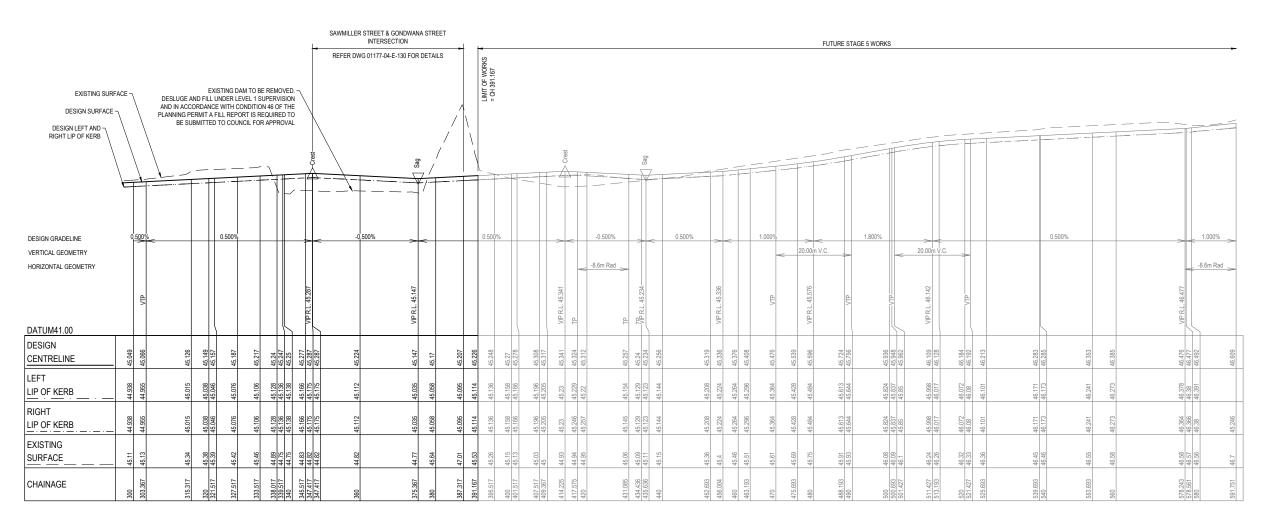

EVERFAIR CRESCENT



WARNING

BEWARE OF UNDERGROUND SERVICES

THE LOCATIONS OF UNDERGROUND SERVICES ARE APPROXIMATE ONLY AND THEIR EXACT POSITION SHOULD BE PROVED ON SITE. NO GUARANTEE IS GIVEN THAT ALL EXISTING SERVICES ARE SHOWN. A MOCS ENQUIRY ON 1100 MUST BE MADE BY THE CONTRACTOR PRIOR TO COMMENCEMENT OF WORKS.

WARNING

IT IS THE RESPONSIBILITY OF THE CONTRACTOR TO VERIFY THE SETOUT INFORMATION PROVIDED ON THIS PLAN WITH THE DESIGN INTENT WHICH INCLUDES, BUT IS NOT LIMITED TO ITEMS SUCH AS LENGTHS, CO-ORDINATES, SETOUT DIMENSIONS AND PEGGED TITLES BY THE PRINCIPAL'S LICENSED SURVEYOR.

> CONSTRUCTION ISSUED FOR CONSTRUCTION

0	20/08/2021	ISSUED FOR CONSTRUCTION - CONTRACTOR	EST	
VER	DATE	REVISION	APPD.	

hillstowe DESIGNED: LOD Levels: AHD CHECKED:

	VERI	U	0.5	1 SCALE 1:50 AT A1 SI SCALE 1:100 AT A3 S	
TWI	A F	3 (
	VI.	Z ;	3		
Urban Development 8 / 270 Ferntree Gully Road, N Tel: 61 3 9501 2800 We	lotting Hill, Vi	ctoria, 3			
AUTHORISED: JO	ΩY	DE	AFTFD.	WGO	

AUTH. DATE: 18/09/2020 CAD REF:

HORIZ

SCALE 1:500 AT A1 SIZE SCALE 1:1000 AT A3 SIZE

WGO

CARDINIA SHIRE COUNCIL 415 PRINCES HIGHWAY, OFFICER VIC 3809 HILLSTOWE ESTATE, STAGE 4

CONTRACTOR

ROAD LONGITUDINAL SECTIONS SHEET 3 OF 5


SCALE	1:50	0 H, 1:50	√ @A1
VERSION		0	
SHEET	15	OF	47
DRAWING	No.		


- ALL EXISTING SERVICES UNDER NEW PAVEMENTS, PATHS AND VEHICLE CROSSINGS TO BE BACKFILLED WITH FOR.

 ALL EXISTING PITS AND MANHOLES WITHIN NEW WORKS TO BE ADJUSTED TO NEATLY MATCH NEW FINISHED SUFFACE.

 ALL EXISTING SEWER PROPERTY BRANCHES AND HOUSE DRAINS DAMAGED BY WORKS TO BE REPLACED BY CONTRACTOR.

 ALL EXISTING OPEN DRAINS TO BE DRAINED, DESLUDGED AND BACKFILLED TO LEVEL 1 REQUIREMENTS.

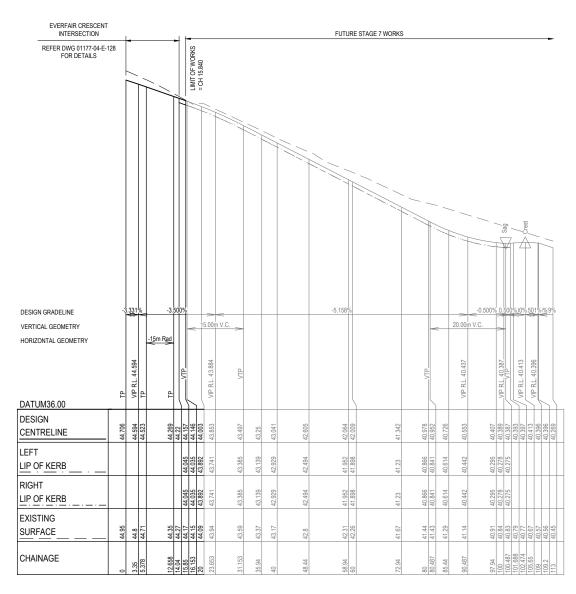

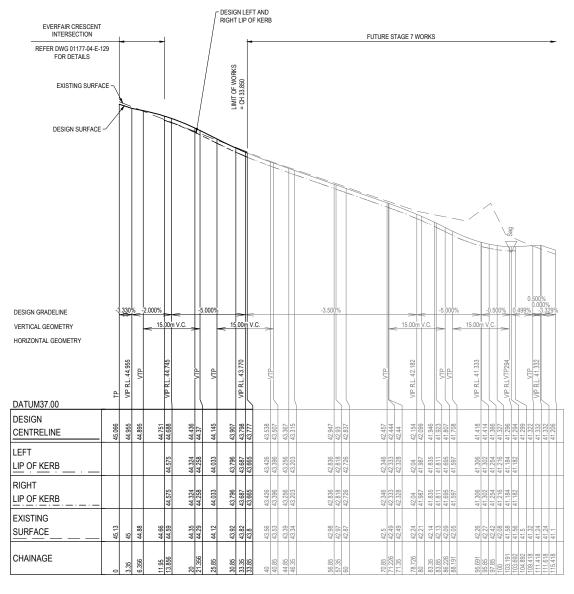

TARKINE STREET

KIELDER STREET

SCALE 1:500 AT A1 SIZE SCALE 1:1000 AT A3 SIZE

SCALE 1:50 AT A1 SIZE SCALE 1:100 AT A3 SIZE



WARNING

BEWARE OF UNDERGROUND SERVICES

THE LOCATIONS OF UNDERGROUND SERVICES ARE APPROXIMATE ONLY AND THEIR EXACT POSITION SHOULD BE PROVED ON SITE. NO GUARANTEE IS GIVEN THAT ALL EXISTING SERVICES ARE SHOWN. A MOCS ENQUIRY ON 1100 MUST BE MADE BY THE CONTRACTOR PRIOR TO COMMENCEMENT OF WORKS.

WARNING

IT IS THE RESPONSIBILITY OF THE CONTRACTOR TO VERIFY THE SETOUT INFORMATION PROVIDED ON THIS PLAN WITH THE DESIGN INTENT WHICH INCLUDES, BUT IS NOT LIMITED TO ITEMS SUCH AS LENGTHS, CO-ORDINATES, SETOUT DIMENSIONS AND PEGGED TITLES BY THE PRINCIPAL'S LICENSED SURVEYOR.

> CONSTRUCTION ISSUED FOR CONSTRUCTION

0	20/08/2021	ISSUED FOR CONSTRUCTION - CONTRACTOR	EST	
VER	DATE	REVISION	APPD.	

hillstowe Levels: AHD CHECKED:

T4YLORS DESIGNED: LOD AUTHORISED: JOY DRAFTED: WGO AUTH. DATE: 18/09/2020 CAD REF:

HORIZ

CARDINIA SHIRE COUNCIL 415 PRINCES HIGHWAY, OFFICER VIC 3809 HILLSTOWE ESTATE, STAGE 4

ROAD LONGITUDINAL SECTIONS

SHEET 4 OF 5

CONTRACTOR


0117	7-(04-E	-115
DRAWING	No.		
SHEET	16	OF	47
VERSION		0	
SCALE	1:50	0 H, 1:50 V	/ @A1

- ALL EXISTING SERVICES UNDER NEW PAVEMENTS, PATHS AND VEHICLE CROSSINGS TO BE BACKFILLED WITH FCR.


 ALL EXISTING PITS AND MANHOLES WITHIN NEW WORKS TO BE ADJUSTED TO NEATLY MATCH NEW FINISHED SUFFACE.

 ALL EXISTING SEWER PROPERTY BRANCHES AND HOUSE DRAINS DAMAGED BY WORKS TO BE REPLACED BY CONTRACTOR.

 ALL EXISTING OPEN DRAINS TO BE DRAINED, DESLUDGED AND BACKFILLED TO LEVEL 1 REQUIREMENTS.

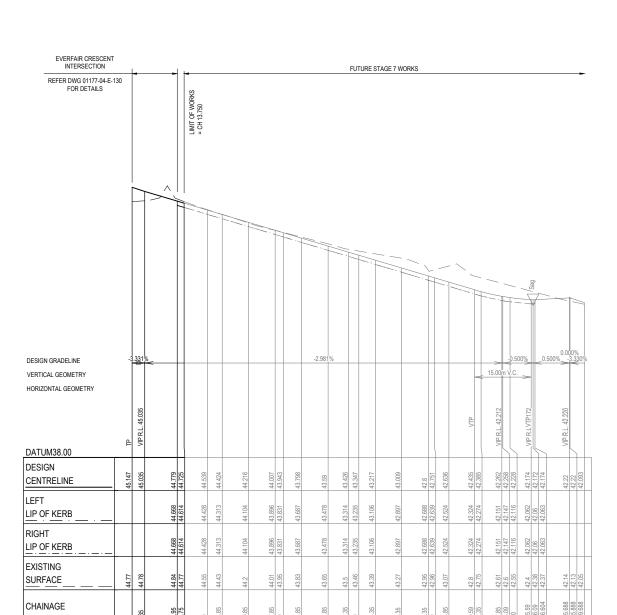

GONDWANA STREET

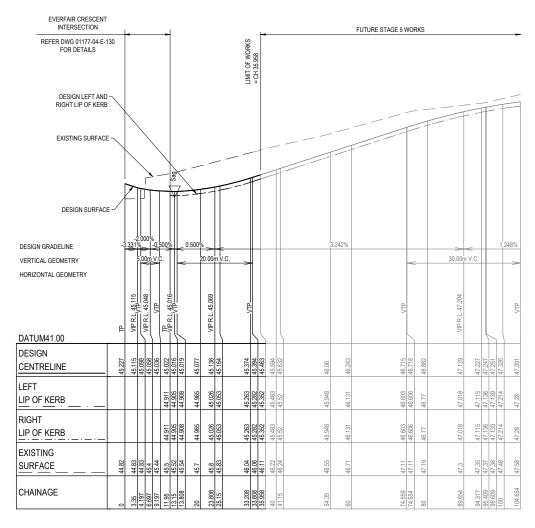

SAWMILLER STREET

SCALE 1:500 AT A1 SIZE SCALE 1:1000 AT A3 SIZE

SCALE 1:50 AT A1 SIZE SCALE 1:100 AT A3 SIZE



WARNING

BEWARE OF UNDERGROUND SERVICES

THE LOCATIONS OF UNDERGROUND SERVICES ARE APPROXIMATE ONLY AND THEIR EXACT POSITION SHOULD BE PROVED ON SITE. NO GUARANTEE IS GIVEN THAT ALL EXISTING SERVICES ARE SHOWN. A MOCS ENQUIRY ON 1100 MUST BE MADE BY THE CONTRACTOR PRIOR TO COMMENCEMENT OF WORKS.

WARNING

IT IS THE RESPONSIBILITY OF THE CONTRACTOR TO VERIFY THE SETOUT INFORMATION PROVIDED ON THIS PLAN WITH THE DESIGN INTENT WHICH INCLUDES, BUT IS NOT LIMITED TO ITEMS SUCH AS LEWGTHS, CC-ORDINATES, SETOUT DIMENSIONS AND PEGGED TITLES BY THE PRINCIPAL'S LICENSED SURVEYOR.

CONSTRUCTION ISSUED FOR CONSTRUCTION

				Γ
				l
0	20/08/2021	ISSUED FOR CONSTRUCTION - CONTRACTOR	EST	
VER	DATE	REVISION	APPD.	



	rban Developm 270 Ferntree Gully Roi Tel: 61 3 9501 2800		a, 3168	
D	AUTHORISED:	JOY	DRAFTED:	WGO

AUTH. DATE: 18/09/2020 CAD REF:


HORIZ


CARDINIA SHIRE COUNCIL 415 PRINCES HIGHWAY, OFFICER VIC 3809 HILLSTOWE ESTATE, STAGE 4


CONTRACTOR


TILLET OWL LOTTIL, OTTIOL 4
ROAD LONGITUDINAL SECTIONS
SHEET 5 OF 5


SCALE	1:50	0 H, 1:50 \	/ @A1
VERSION		0	
SHEET	17	OF	47
DRAWING	No.		
0117	7-(04-E	-116

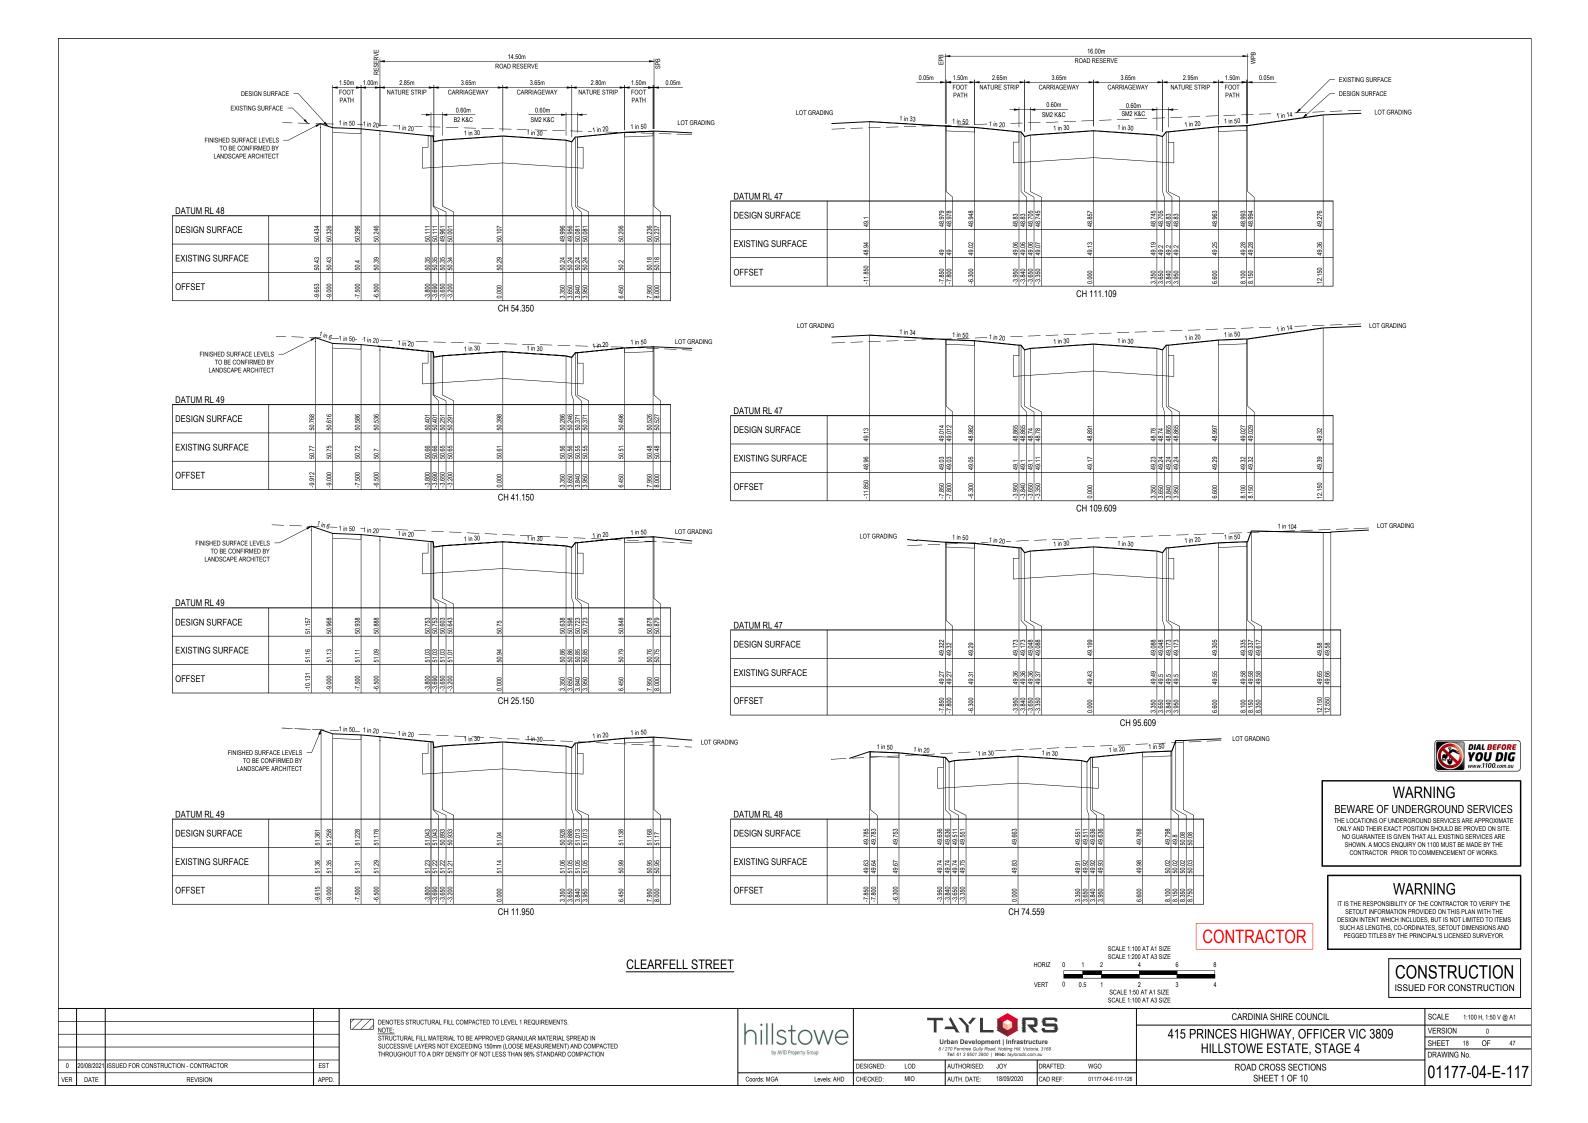


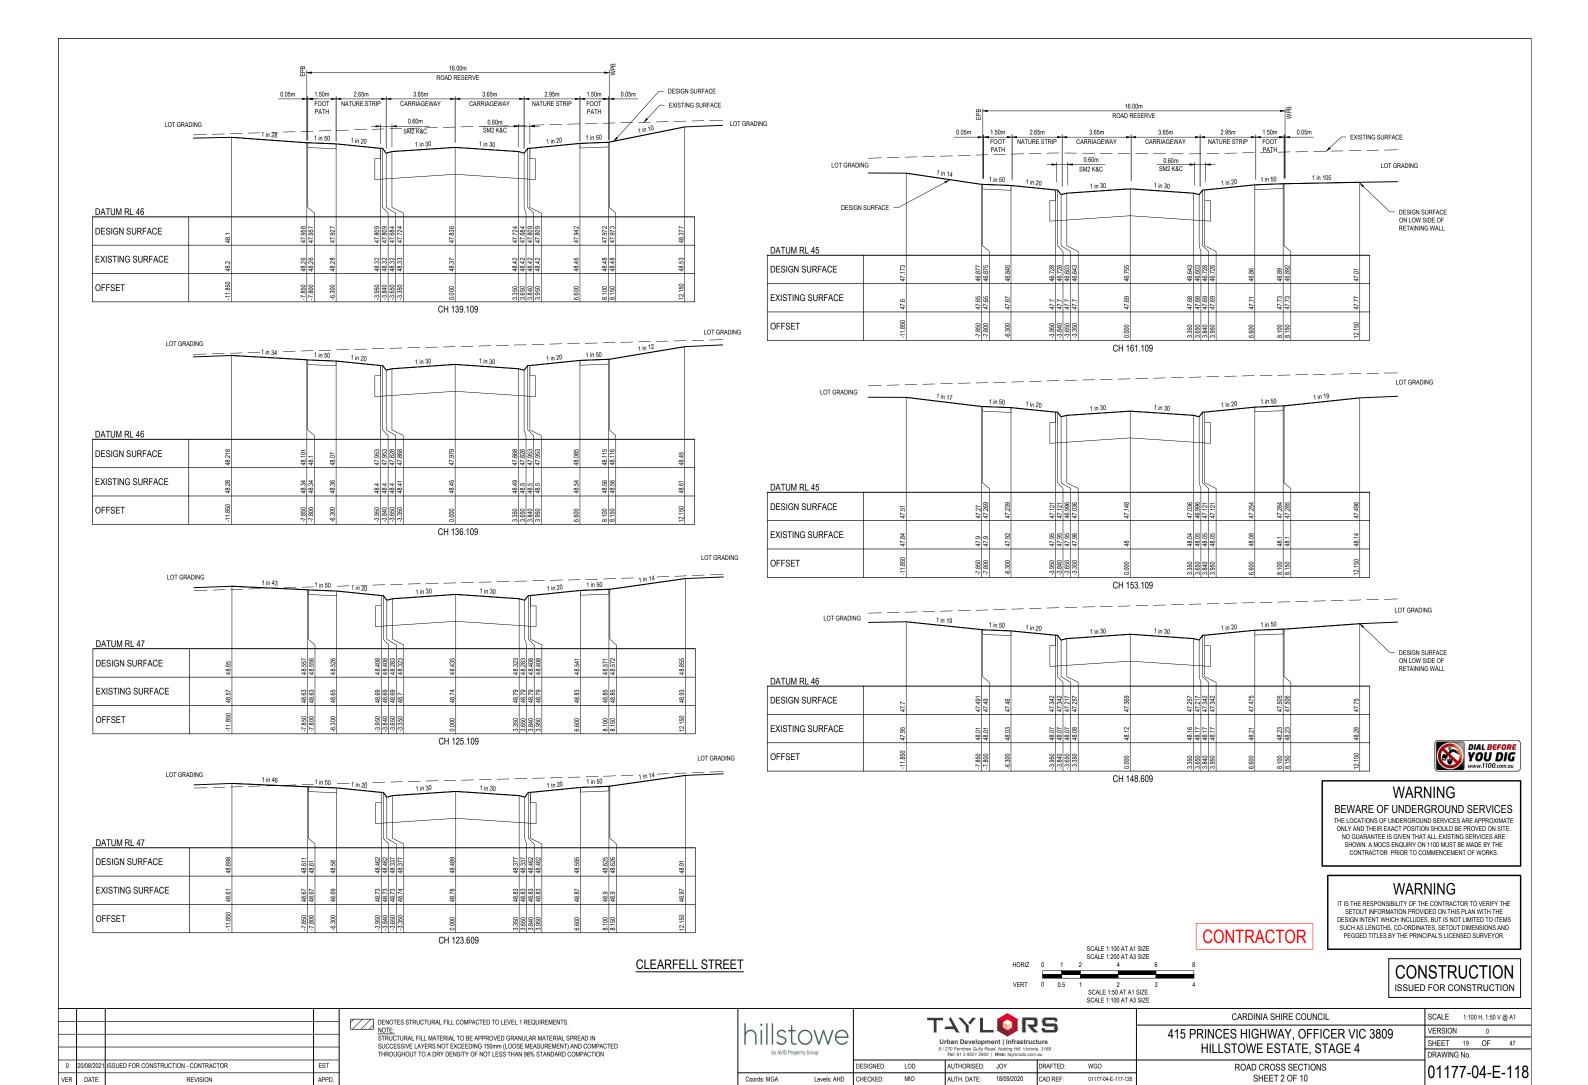


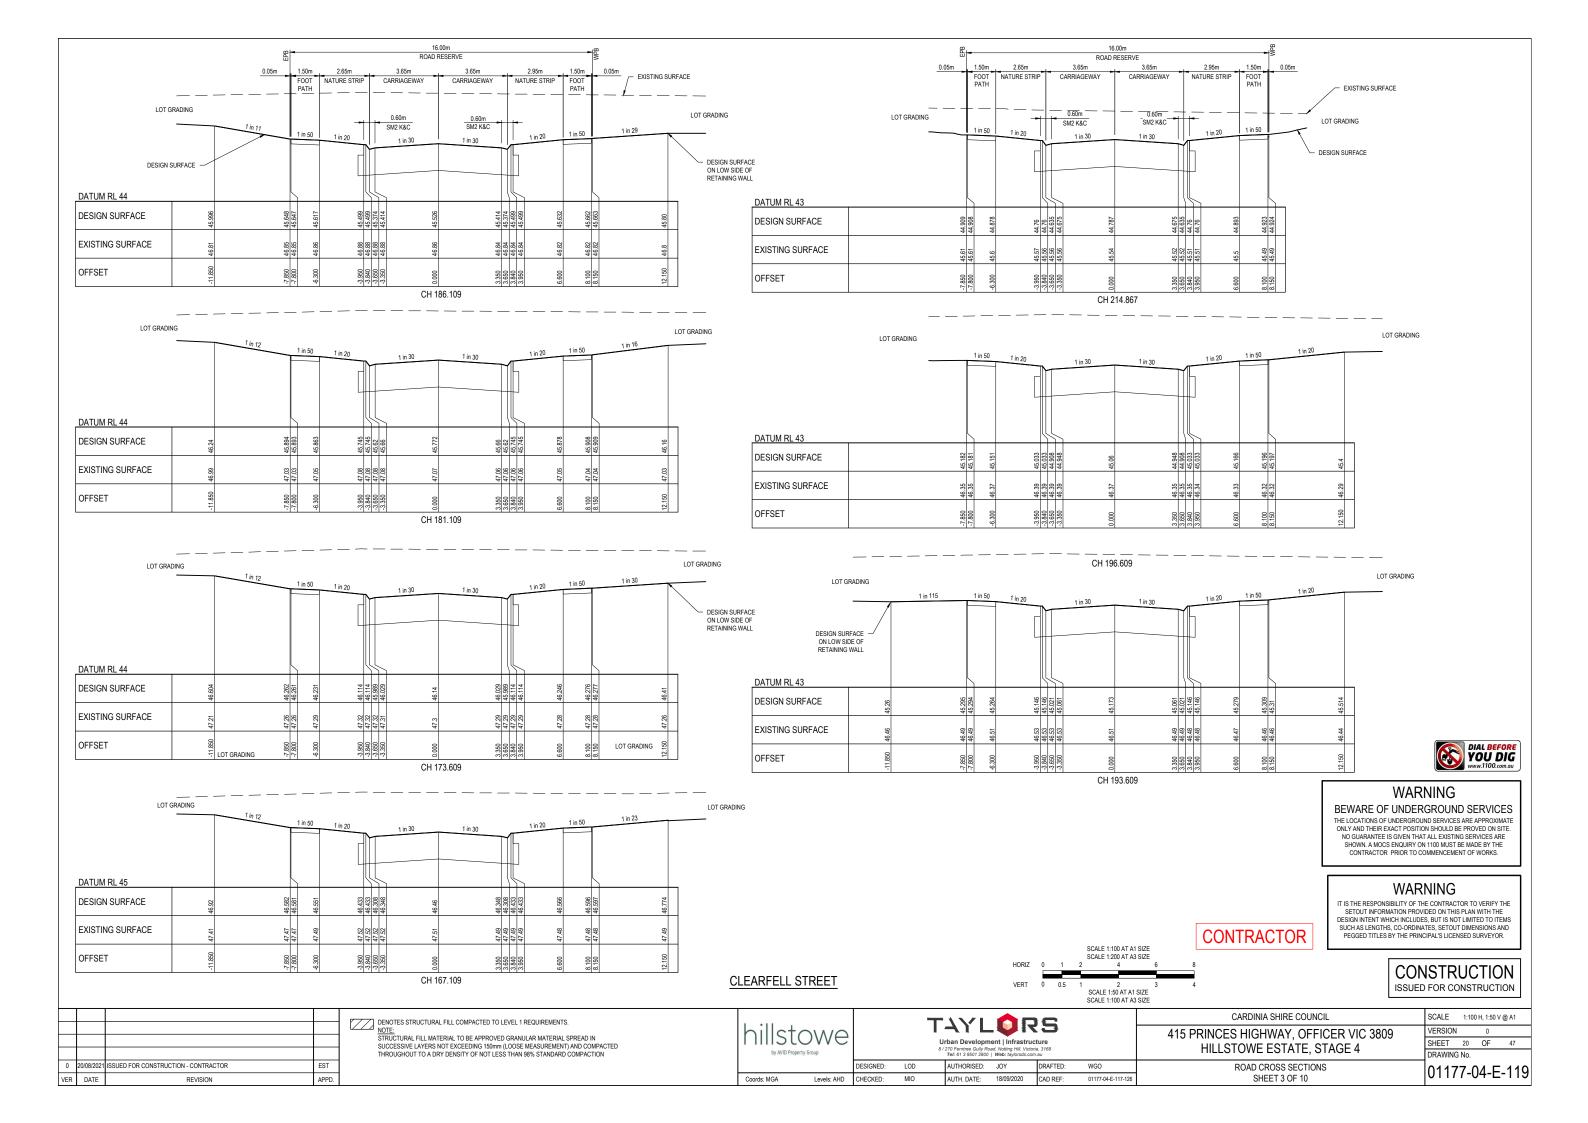


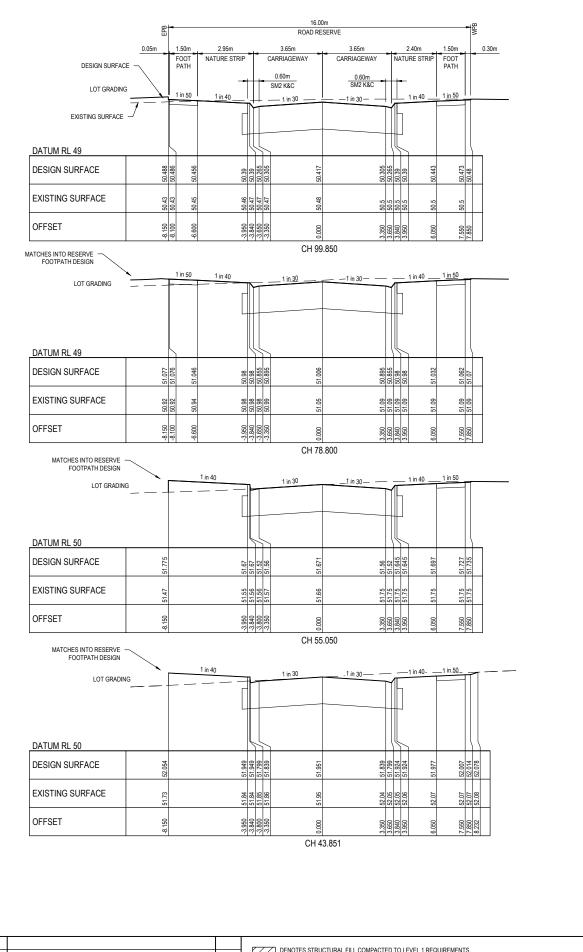

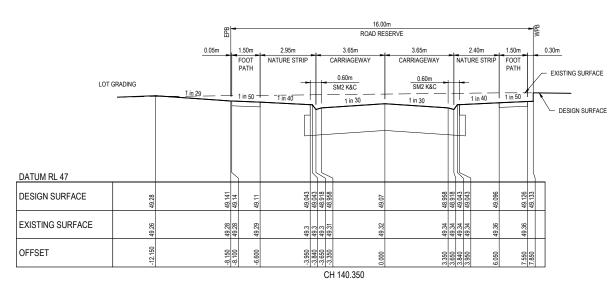

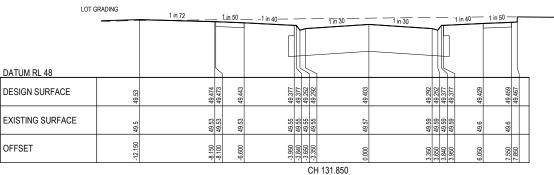

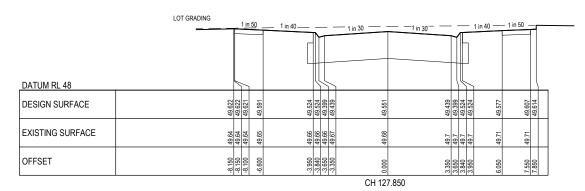

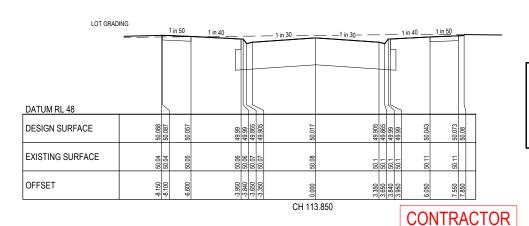

HORIZ.

SCALE 1:100 AT A1 SIZE SCALE 1:200 AT A3 SIZE

SCALE 1:50 AT A1 SIZE SCALE 1:100 AT A3 SIZE

WGO



WARNING

BEWARE OF UNDERGROUND SERVICES

THE LOCATIONS OF UNDERGROUND SERVICES ARE APPROXIMATE ONLY AND THEIR EXACT POSITION SHOULD BE PROVED ON SITE. NO GUARANTEE IS GIVEN THAT ALL EXISTING SERVICES ARE SHOWN. A MOCS ENQUIRY ON 1100 MUST BE MADE BY THE CONTRACTOR PRIOR TO COMMENCEMENT OF WORKS.

WARNING

IT IS THE RESPONSIBILITY OF THE CONTRACTOR TO VERIFY THE SETOUT INFORMATION PROVIDED ON THIS PLAN WITH THE DESIGN INTENT WHICH INCLUDES, BUT IS NOT LIMITED TO ITEMS SUCH AS LENGTHS, CO-ORDINATES, SETOUT DIMENSIONS AND PEGGED TITLES BY THE PRINCIPAL'S LICENSED SURVEYOR.

> CONSTRUCTION ISSUED FOR CONSTRUCTION

DENOTES STRUCTURAL FILL COMPACTED TO LEVEL 1 R
STRUCTURAL FILL MATERIAL TO BE APPROVED GRANUL

EST

APPD.

0 20/08/2021 ISSUED FOR CONSTRUCTION - CONTRACTOR

REVISION

VER DATE

LAR MATERIAL SPREAD IN UCCESSIVE LAYERS NOT EXCEEDING 150mm (LOOSE MEASUREMENT) AND COMPACTED THROUGHOUT TO A DRY DENSITY OF NOT LESS THAN 98% STANDARD COMPACTION

nillst by AVID Prope	OWE	TAYLORS Urban Development Infrastructure 8/270 Femrines Guily Road, Notting Hill, Viction; 3/188 Tel: 61 3/80 1/2001 Webs. triplycast.com au						
		DESIGNED:	LOD		AUTHORISED:	JOY	DRAFTED:	
oords: MGA	Levels: AHD	CHECKED:	MIO		AUTH. DATE:	18/09/2020	CAD REF:	


EVERFAIR CRESCENT


Coords: MGA


CARDINIA SHIRE COUNCIL
415 PRINCES HIGHWAY, OFFICER VIC 3809 HILLSTOWE ESTATE, STAGE 4
ROAD CROSS SECTIONS


SHEET 4 OF 10


SCALE	1:10	0 H, 1:50 \	/ @ A1
VERSION		0	
SHEET	21	OF	47
DRAWING	No.		

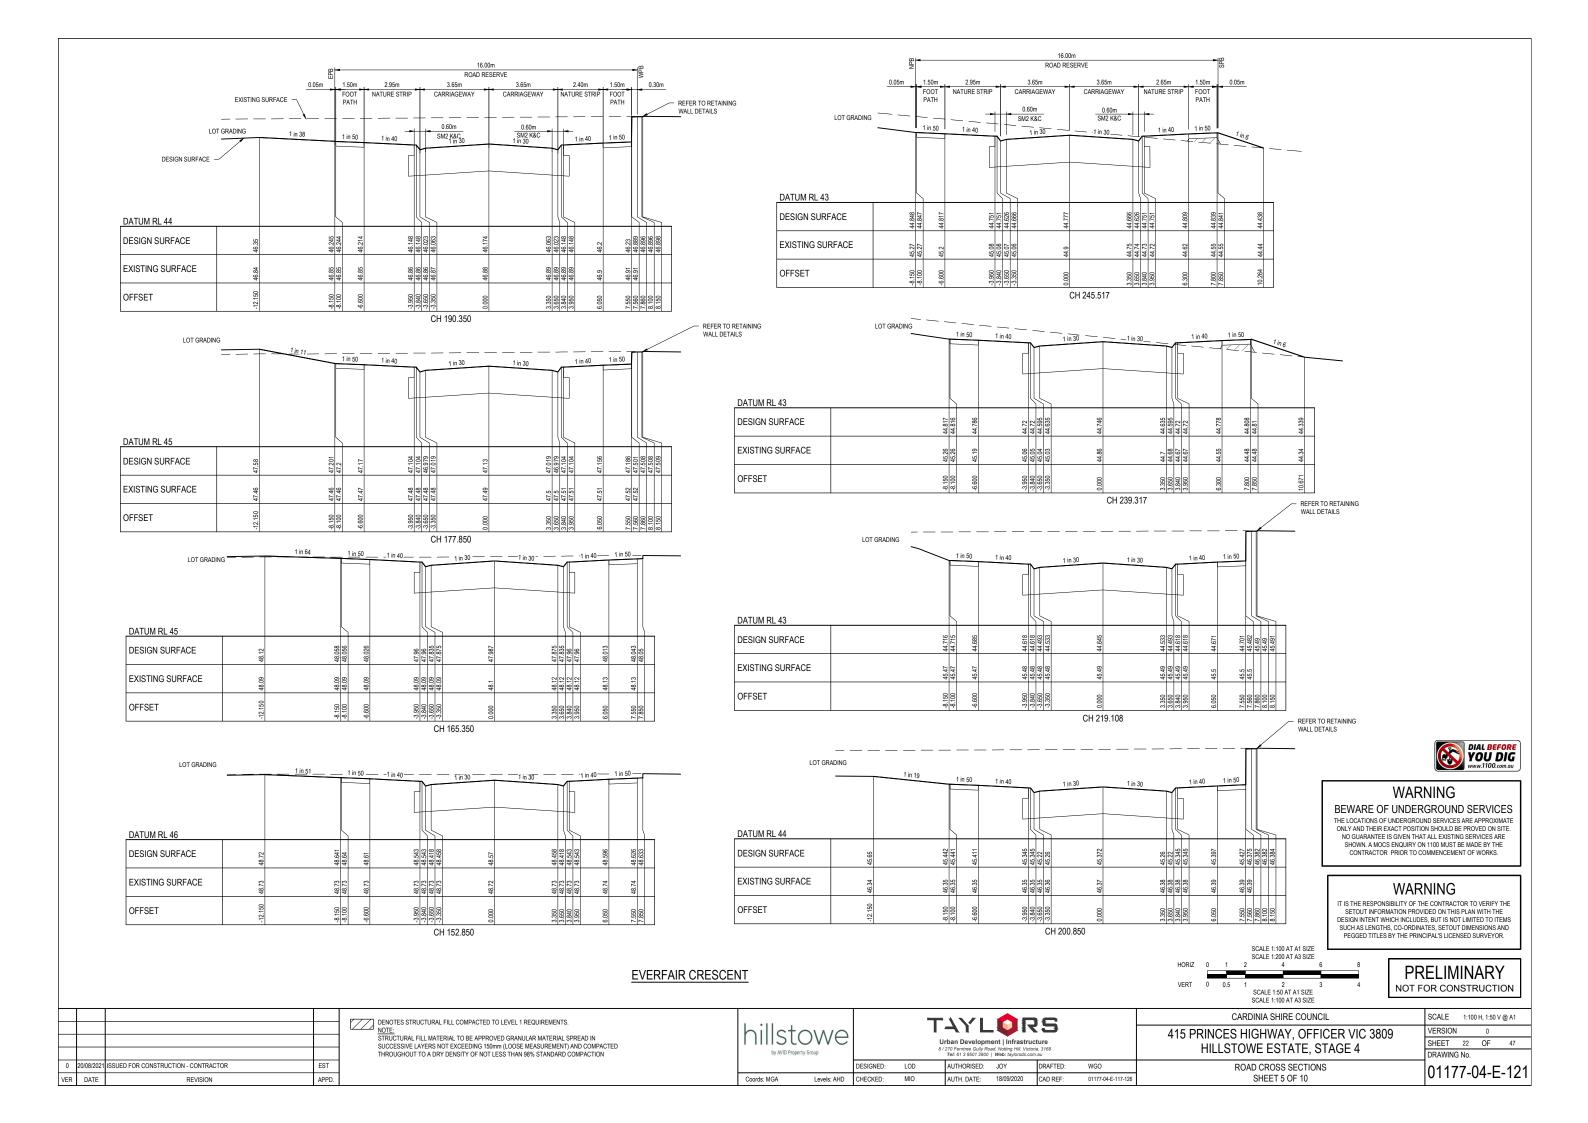

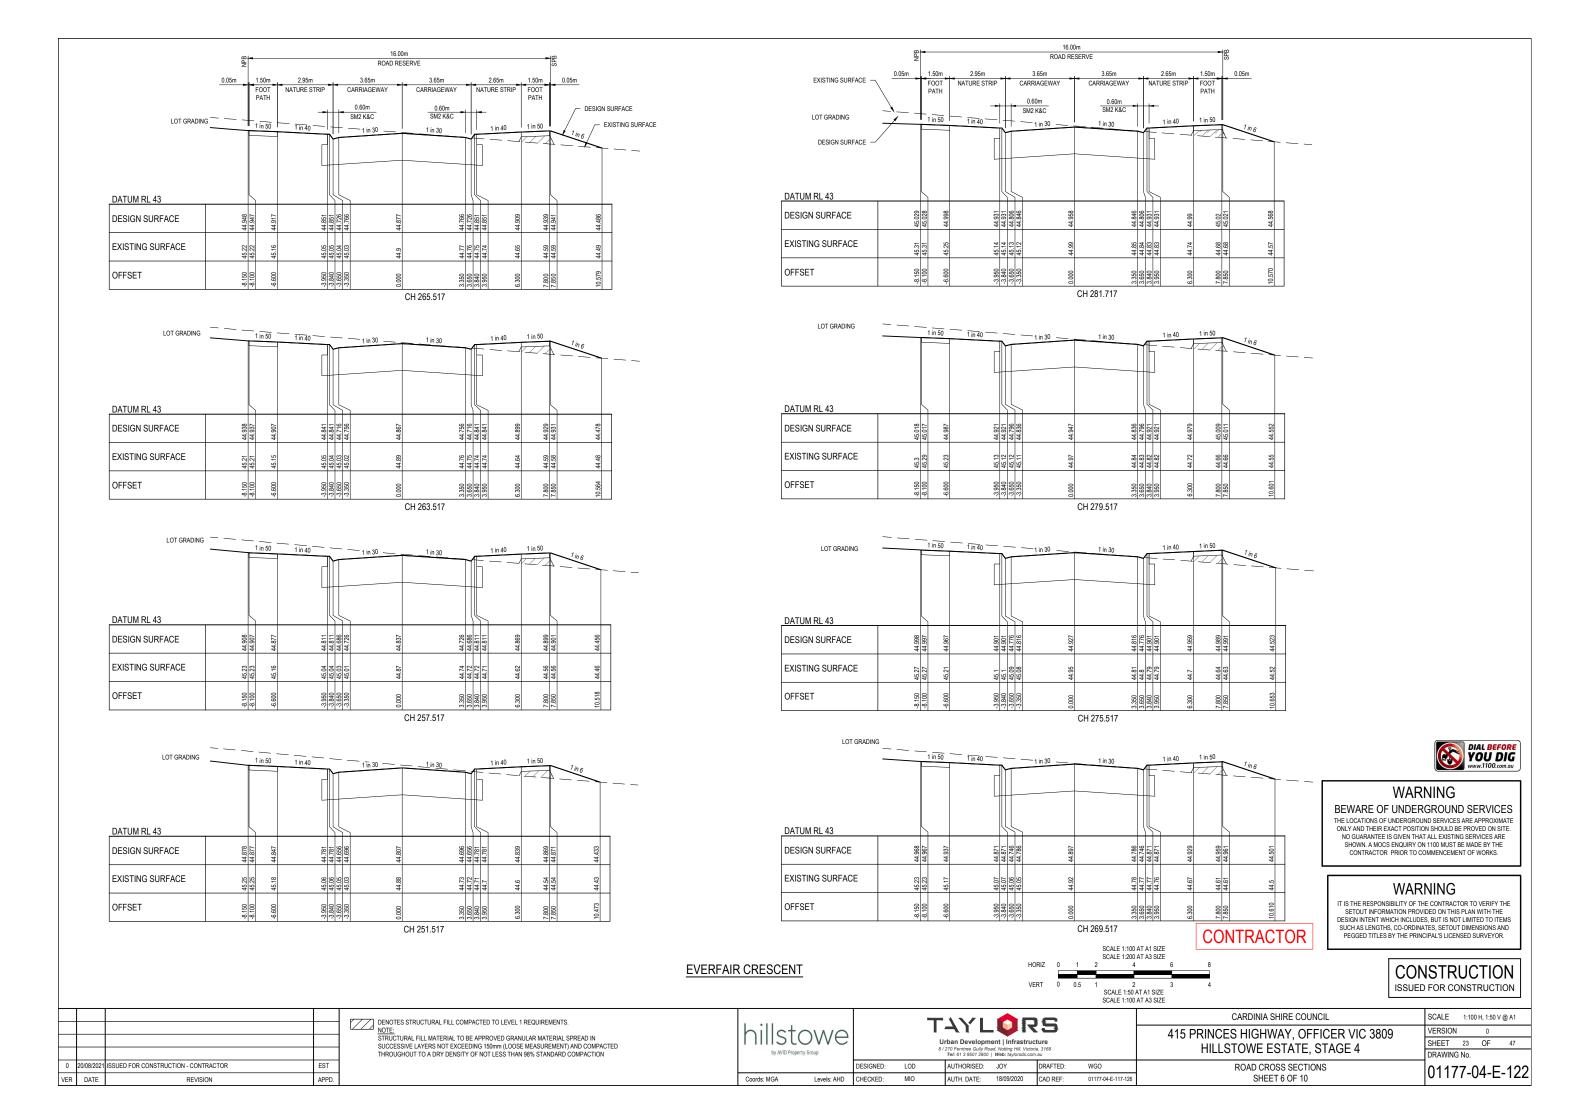


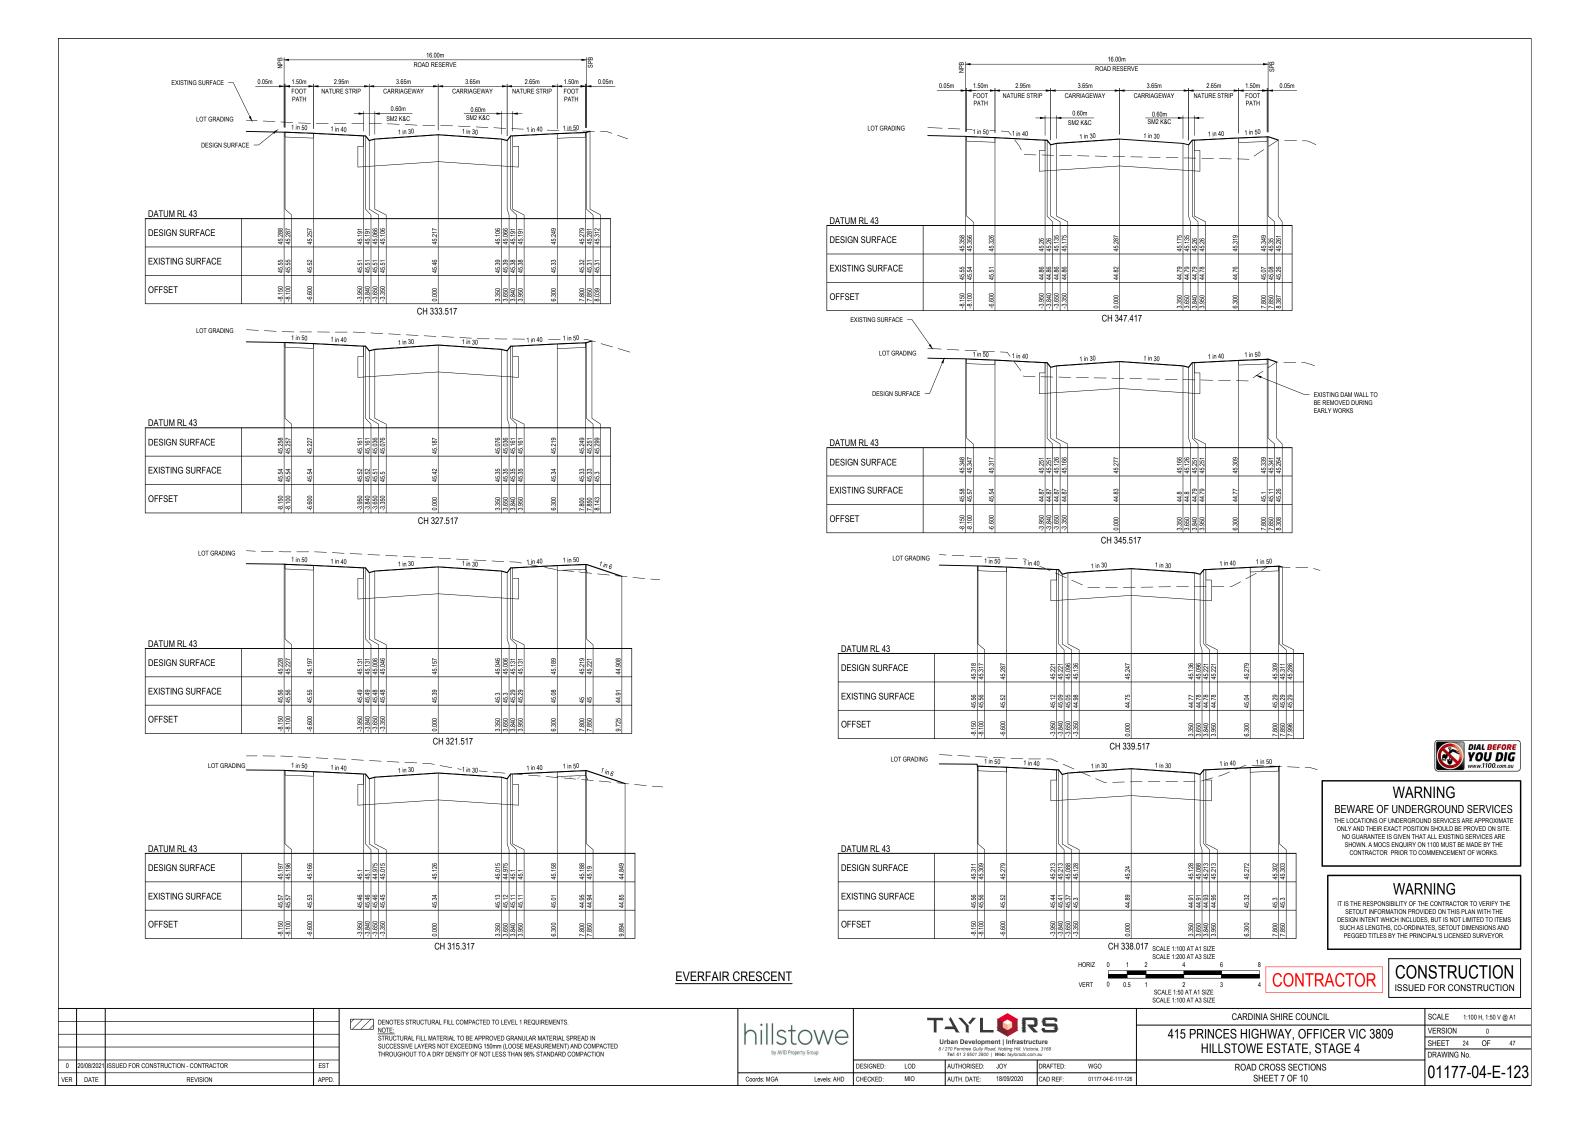

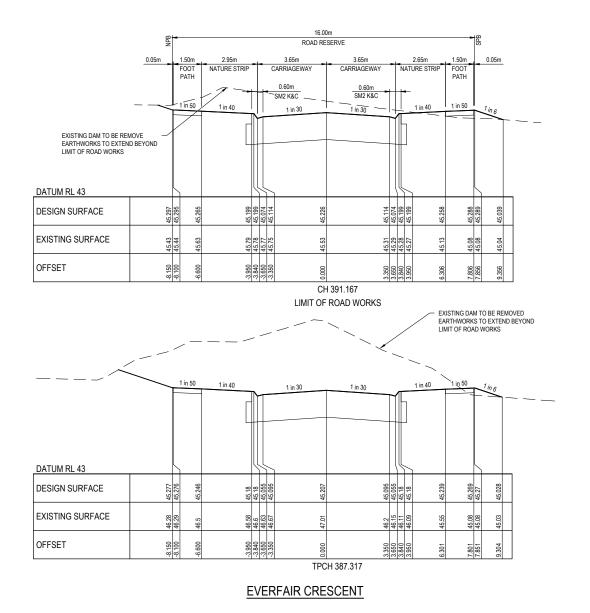

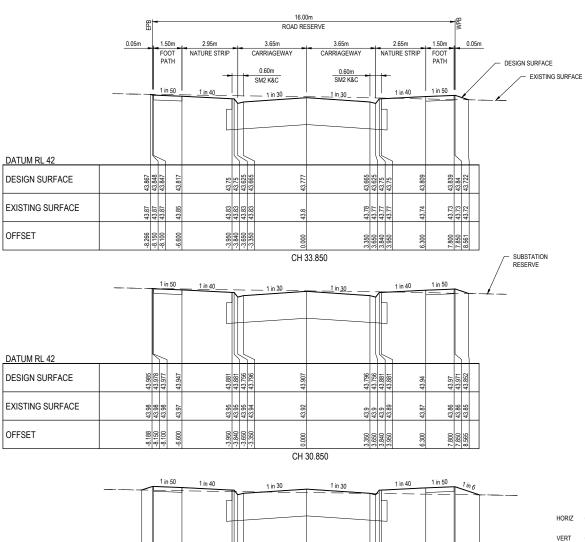

KIELDER STREET

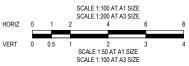



WARNING

BEWARE OF UNDERGROUND SERVICES

THE LOCATIONS OF UNDERGROUND SERVICES ARE APPROXIMATE ONLY AND THEIR EXACT POSITION SHOULD BE PROVED ON SITE. NO GUARANTEE IS GIVEN THAT ALL EXISTING SERVICES ARE SHOWN. A MOCS ENQUIRY ON 1100 MUST BE MADE BY THE CONTRACTOR PRIOR TO COMMENCEMENT OF WORKS.

WARNING

IT IS THE RESPONSIBILITY OF THE CONTRACTOR TO VERIFY THE SETOUT INFORMATION PROVIDED ON THIS PLAN WITH THE DESIGN INTENT WHICH INCLUDES, BUT IS NOT LIMITED TO ITEMS SUCH AS LEWGHAS, CO-ORDINATES, SETOUT DIMENSIONS AND PEGGED TITLES BY THE PRINCIPAL'S LICENSED SURVEYOR.

CONSTRUCTION ISSUED FOR CONSTRUCTION

0	20/08/2021	ISSUED FOR CONSTRUCTION - CONTRACTOR	EST
VER	DATE	REVISION	APPD.

DENOTES STRUCTURAL FILL COMPACTED TO LEVEL 1 REQUIREMENTS. NOTE:

NOTE: STRUCTURAL FILL MATERIAL TO BE APPROVED GRANULAR MATERIAL SPREAD IN SUCCESSIVE LAYERS NOT EXCEEDING 150mm (LOOSE MEASUREMENT) AND COMPACTED THROUGHOUT TO A DRY DENSITY OF NOT LESS THAN 98% STANDARD COMPACTION



DATUM RL 43

OFFSET

DESIGN SURFACE

EXISTING SURFACE

	270 Ferntree Gully Ro	nent Infrastructiad, Notting Hill, Victoria Web: taylorsds.com.	a, 3168	
D	AUTHORISED:	JOY	DRAFTED:	WGO


AUTH. DATE: 18/09/2020 CAD REF:


CARDINIA SHIRE COUNCIL
415 PRINCES HIGHWAY, OFFICER VIC 3809
HILLSTOWE ESTATE, STAGE 4

CONTRACTOR

	SCALE	1:10	0 H, 1:50 V	@ P
)	VERSION		0	
1	SHEET	25	OF	4
	DRAWING	No.		

ROAD CROSS SECTIONS SHEET 8 OF 10

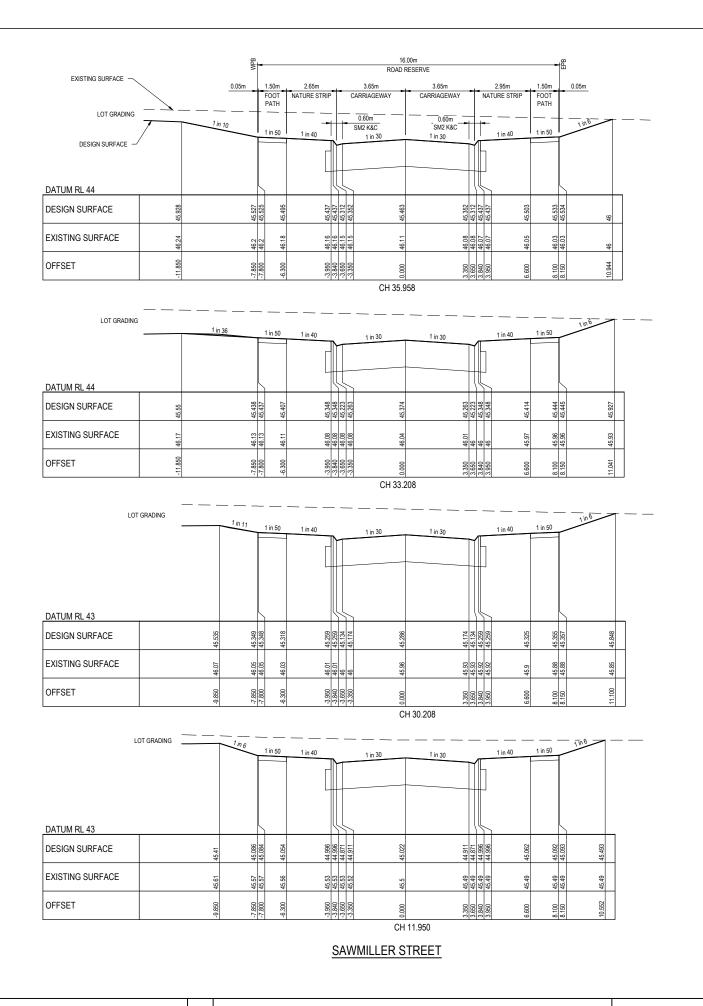

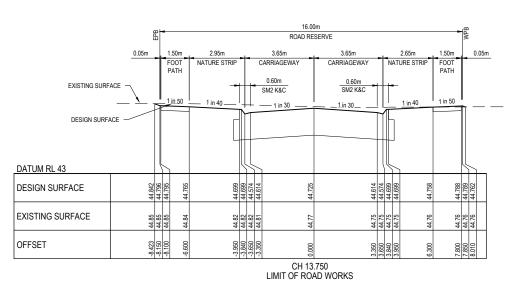

— 1 in 30 — DATUM RL 43 DESIGN SURFACE EXISTING SURFACE 44.92 44.88 44.88 44.88 44.86 OFFSET TPCH 11.950

WGO

GONDWANNA STREET



WARNING


BEWARE OF UNDERGROUND SERVICES

THE LOCATIONS OF UNDERGROUND SERVICES ARE APPROXIMATE ONLY AND THEIR EXACT POSITION SHOULD BE PROVED ON SITE. NO GUARANTEE IS GIVEN THAT ALL EXISTING SERVICES ARE SHOWN. A MOCS ENQUIRY ON 1100 MUST BE MADE BY THE CONTRACTOR PRIOR TO COMMENCEMENT OF WORKS.

WARNING

CONTRACTOR

IT IS THE RESPONSIBILITY OF THE CONTRACTOR TO VERIFY THE SETOUT INFORMATION PROVIDED ON THIS PLAN WITH THE DESIGN INTENT WHICH INCLUDES, BUT IS NOT LIMITED TO ITEMS SUCH AS LENGTHS, CO-ORDINATES, SETOUT DIMENSIONS AND PEGGED TITLES BY THE PRINCIPAL'S LICENSED SURVEYOR.

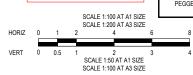

CONSTRUCTION ISSUED FOR CONSTRUCTION

0	20/08/2021	ISSUED FOR CONSTRUCTION - CONTRACTOR	EST
VER	DATE	REVISION	APPD.

DENOTES STRUCTURAL FILL COMPACTED TO LEVEL 1 REQUIREMENTS.

NOTE:
STRUCTURAL FILL MATERIAL TO BE APPROVED GRANULAR MATERIAL SPREAD IN
SUCCESSIVE LAYERS NOT EXCEEDING 150mm (LOOSE MEASUREMENT) AND COMPACTED
THROUGHOUT TO A DRY DENSITY OF NOT LESS THAN 98% STANDARD COMPACTION



Levels: AHD CHECKED:

	ı	8/2	than Developm 270 Ferntree Gully Ro Tel: 61 3 9501 2800	ad, Notting Hi	II, Victoria, 3168
DESIGNED:	LOD		AUTHORISED:	JOY	DRAFTED:


AUTH. DATE: 18/09/2020 CAD REF:

CARDINIA SHIRE COUNCIL 415 PRINCES HIGHWAY, OFFICER VIC 3809


HILLSTOWE ESTATE, STAGE 4 ROAD CROSS SECTIONS

SCALE	1:10	00 H, 1:50 V	' @ A1
VERSION		0	
SHEET	26	OF	47
DRAWING	Nο		


01177-04-E-125 SHEET 9 OF 10

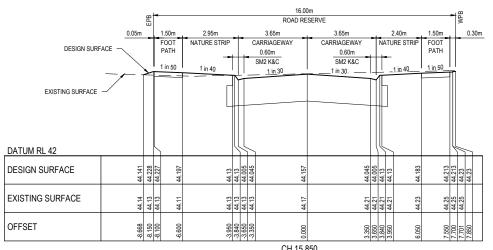

CH 15.850 LIMIT OF ROAD WORKS

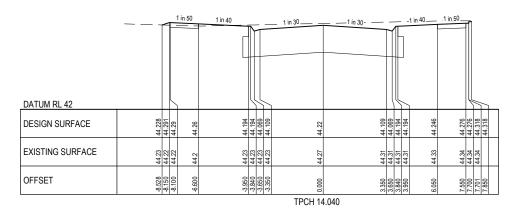

TARKINE STREET

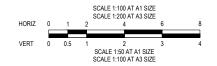



WARNING

BEWARE OF UNDERGROUND SERVICES

THE LOCATIONS OF UNDERGROUND SERVICES ARE APPROXIMATE ONLY AND THEIR EXACT POSITION SHOULD BE PROVED ON SITE. NO GUARANTEE IS GIVEN THAT ALL EXISTING SERVICES ARE SHOWN. A MOCS ENQUIRY ON 1100 MUST BE MADE BY THE CONTRACTOR PRIOR TO COMMENCEMENT OF WORKS.

WARNING

CONTRACTOR

IT IS THE RESPONSIBILITY OF THE CONTRACTOR TO VERIFY THE SETOUT INFORMATION PROVIDED ON THIS PLAN WITH THE DESIGN INTENT WHICH INCLUDES, BUT IS NOT LIMITED TO ITEMS SUCH AS LENGTHS, CO-ORDINATES, SETOUT DIMENSIONS AND PEGGED TITLES BY THE PRINCIPAL'S LICENSED SURVEYOR.

CONSTRUCTION ISSUED FOR CONSTRUCTION

0	20/08/2021	ISSUED FOR CONSTRUCTION - CONTRACTOR	EST
VER	DATE	REVISION	APPD.

DENOTES STRUCTURAL FILL COMPACTED TO LEVEL 1 REQUIREMENTS. NOTE:

NOTE: STRUCTURAL FILL MATERIAL TO BE APPROVED GRANULAR MATERIAL SPREAD IN SUCCESSIVE LAYERS NOT EXCEEDING 150mm (LOOSE MEASUREMENT) AND COMPACTED THROUGHOUT TO A DRY DENSITY OF NOT LESS THAN 98% STANDARD COMPACTION



	rban Developm 270 Ferntree Gully Ro Tel: 61 3 9501 2800		a, 3168	
D	AUTHORISED:	JOY	DRAFTED:	WGO


AUTH. DATE: 18/09/2020 CAD REF:


CARDINIA SHIRE COUNCIL	
415 PRINCES HIGHWAY, OFFICER VIC 3809	
HILLSTOWE ESTATE, STAGE 4	

ILLOTOWE LOTTIL, OTTIO	
ROAD CROSS SECTIONS	
SHEET 10 OF 10	


SCALE	1:10	00 H, 1:50 V	' @ A1
VERSION		0	
SHEET	27	OF	47
DRAWING	Nο		


S SECTIONS 01177-04-E-126

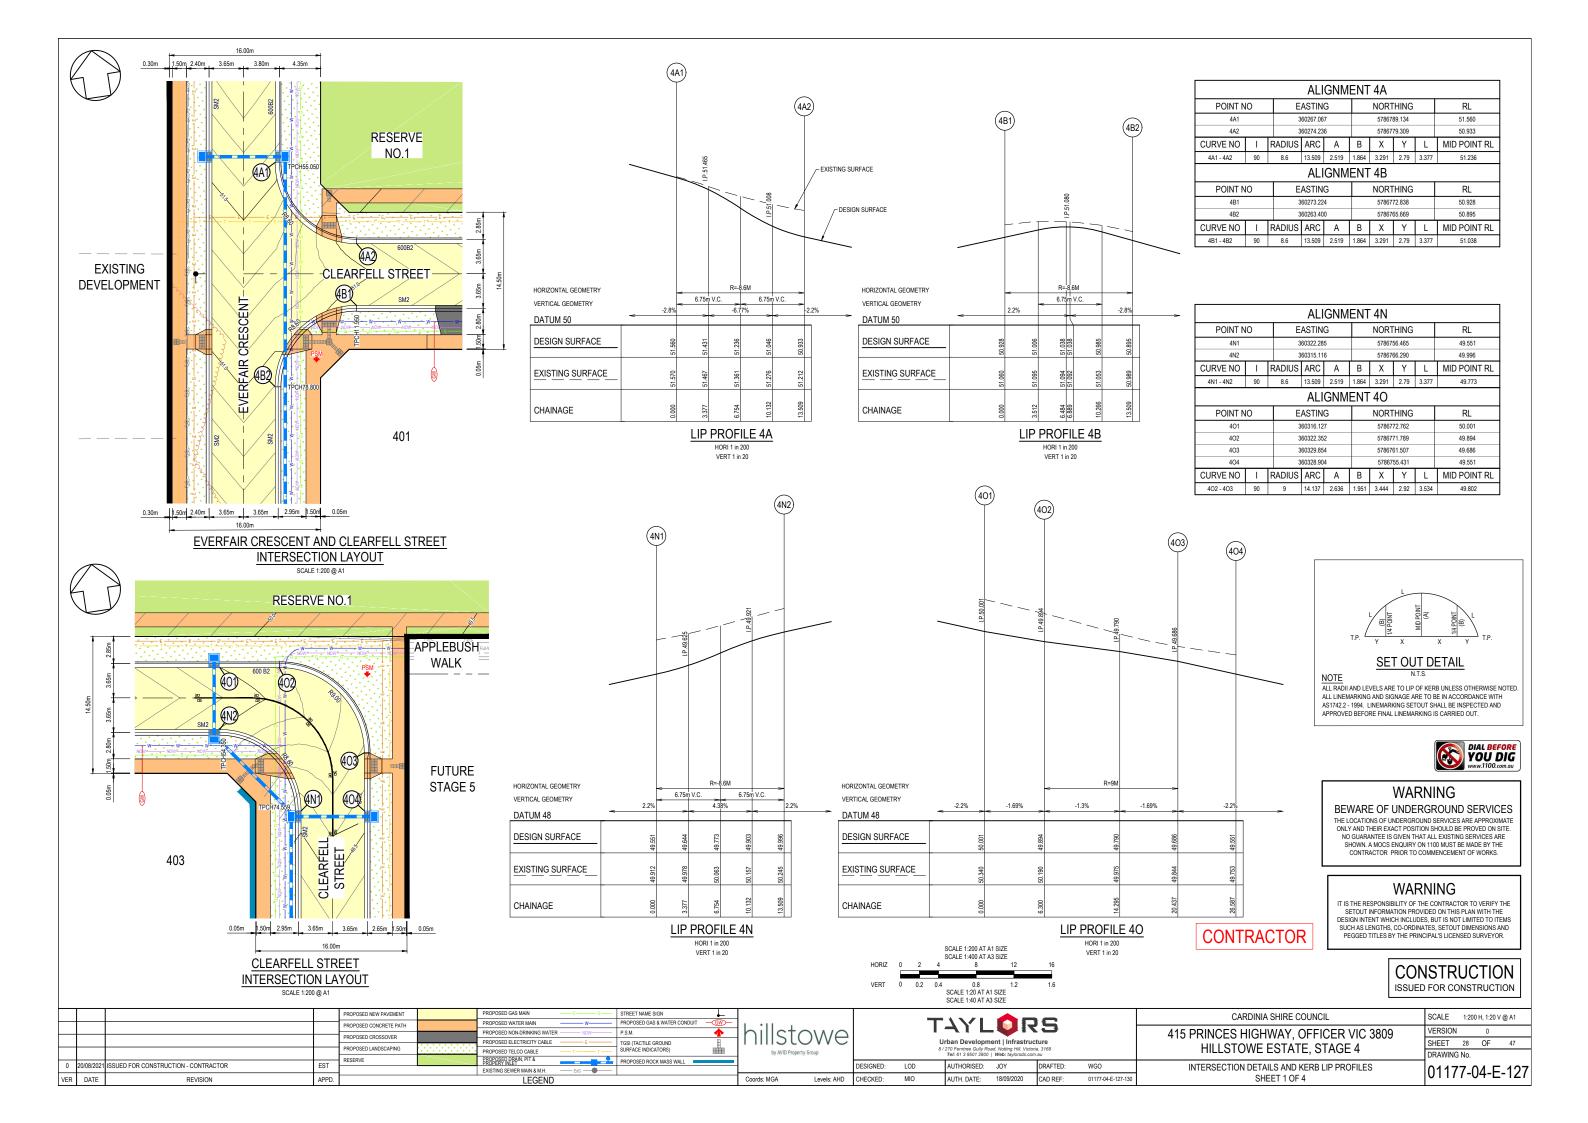


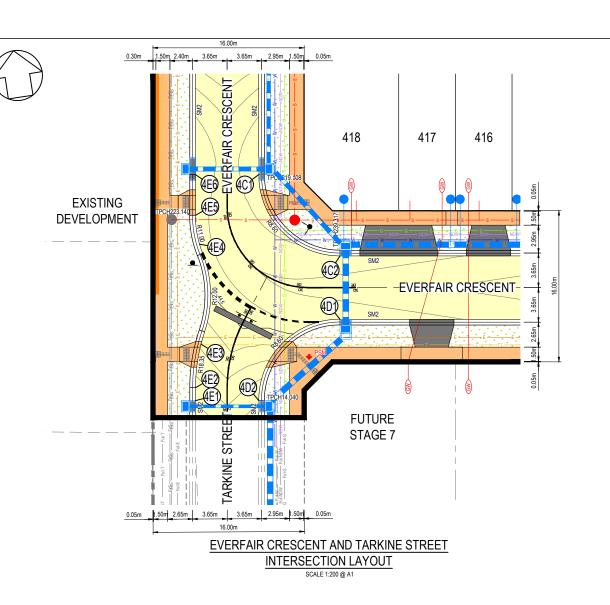


ALIGNMENT 4C											
POINT N	10	E	EASTING			NORT	HING	RL			
4C1		3	360241.733			57866	27.044		44.533		
4C2		3	360248.902			57866	17.219	44.635			
CURVE NO	Ι	RADIUS	ARC	Α	В	Х	Υ	L	MID POINT RL		
4C1 - 4C2	90	8.6	13.509	2.519	1.864	3.291	2.79	3.377	44.584		
ALIGNMENT 4D											
POINT N	E	EASTING			NORT	HING	RL				
4D1		3	60247.86	7		57866	10.600	44.635			
4D2		3	360238.042			5786603.431			44.109		
CURVE NO	1	RADIUS	ARC	Α	В	X Y L		L	MID POINT RL		
4D1 - 4D2	90	8.6	13.509	2.519	1.864	3.291	2.79	3.377	44.422		
			ALI	GNM	ENT	4E					
POINT NO EASTING					NORTHING				RL		
4E1		3	360231.422			5786604.466			44.109		
4E2		3	360231.636			5786605.831			44.157		
4E3		;	360233.51			5786611.51			44.369		
4E4	3	360234.586			5786619.714			44.558			
4E5	3	360234.449			5786623.83			44.555			
4E6		3	360235.113			5786628.079			44.533		
CURVE NO	_	RADIUS	ARC	Α	В	Χ	Υ	اــ	MID POINT RL		
4E2 - 4E3	18.756	18.35	6.007	0.245	0.184	1.5	1.49	1.502	44.263		
4E3 - 4E4	40.336	12	8.448	0.736	0.55	0.55 2.101 2.036 2.112		44.5			
4E4 - 4E5	21.58	11	4.143	0.194	0.146 1.034 1.025 1.036			1.036	44.565		

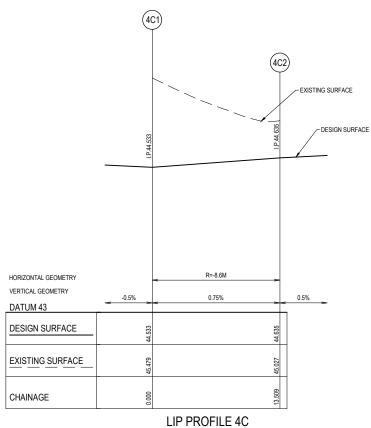

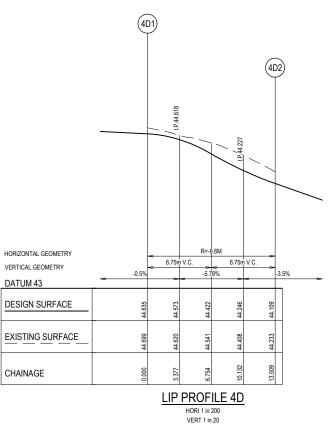

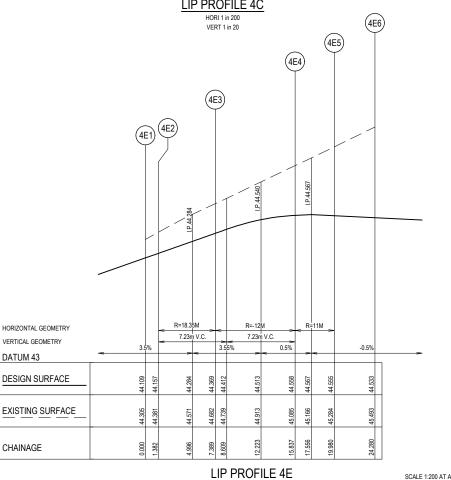

HORI 1 in 200 VERT 1 in 20

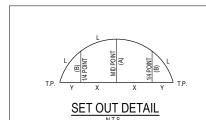

ALL RADII AND LEVELS ARE TO LIP OF KERB UNLESS OTHERWISE NOTED. ALL LINEMARKING AND SIGNAGE ARE TO BE IN ACCORDANCE WITH AS1742.2 - 1994. LINEMARKING SETOUT SHALL BE INSPECTED AND APPROVED BEFORE FINAL LINEMARKING IS CARRIED OUT.



WARNING

BEWARE OF UNDERGROUND SERVICES

THE LOCATIONS OF UNDERGROUND SERVICES ARE APPROXIMATE ONLY AND THEIR EXACT POSITION SHOULD BE PROVED ON SITE. NO GUARANTEE IS GIVEN THAT ALL EXISTING SERVICES ARE SHOWN. A MOCS ENQUIRY ON 1100 MUST BE MADE BY THE CONTRACTOR PRIOR TO COMMENCEMENT OF WORKS.

WARNING

IT IS THE RESPONSIBILITY OF THE CONTRACTOR TO VERIFY THE SETOUT INFORMATION PROVIDED ON THIS PLAN WITH THE DESIGN INTENT WHICH INCLUDES, BUT IS NOT LIMITED TO ITEMS SUCH AS LENGTHS, CO-ORDINATES, SETOUT DIMENSIONS AND PEGGED TITLES BY THE PRINCIPAL'S LICENSED SURVEYOR.

> CONSTRUCTION ISSUED FOR CONSTRUCTION

		REVISION	APPD.			LEGEND				
0	20/08/2021	ISSUED FOR CONSTRUCTION - CONTRACTOR	EST			PROPOSED DRAIN, PIT & PROPERY INLET				\vdash
	00/00/000/	TOOLIER FOR COLUMN AND TOOLIER LOTTER		EXISTING SEWER MAIN & M.H. —	ExS	PROPOSED SEWER MAIN & M.H.	s	PROPOSED RETAINING WALL		1
				PROPOSED LANDSCAPING		PROPOSED TELCO CABLE	— T—— T—	SURFACE INDICATORS)		1
						PROPOSED ELECTRICITY CABLE	——Е——	TGSI (TACTILE GROUND	B	ı
\vdash				PROPOSED CROSSOVER		PROPOSED NON-DRINKING WATE	ER NDW	P.S.M.	1	ık
				PROPOSED CONCRETE PATH		PROPOSED WATER MAIN	w	PROPOSED GAS & WATER CONDUIT	-@V-	1
				PROPOSED NEW PAVEMENT		PROPOSED GAS MAIN	— G—— G—	STREET NAME SIGN		Ī

hillstowe DESIGNED: LOD Coords: MGA

Levels: AHD CHECKED:

DATUM 43

CHAINAGE

T4YLORS AUTHORISED: JOY DRAFTED:

AUTH. DATE: 18/09/2020 CAD REF:

415 PRINCES HIGHWAY, OFFICER VIC 3809 HILLSTOWE ESTATE, STAGE 4

CARDINIA SHIRE COUNCIL

CONTRACTOR

SCALE 1:200 AT A1 SIZE SCALE 1:400 AT A3 SIZE

0.8 SCALE 1:20 AT A1 SIZE SCALE 1:40 AT A3 SIZE


WGO


VERSION SHEET 29 OF 47 DRAWING No.


INTERSECTION DETAILS AND KERB LIP PROFILES SHEET 2 OF 4


01177-04-E-128

SCALE 1:200 H, 1:20 V @ A1

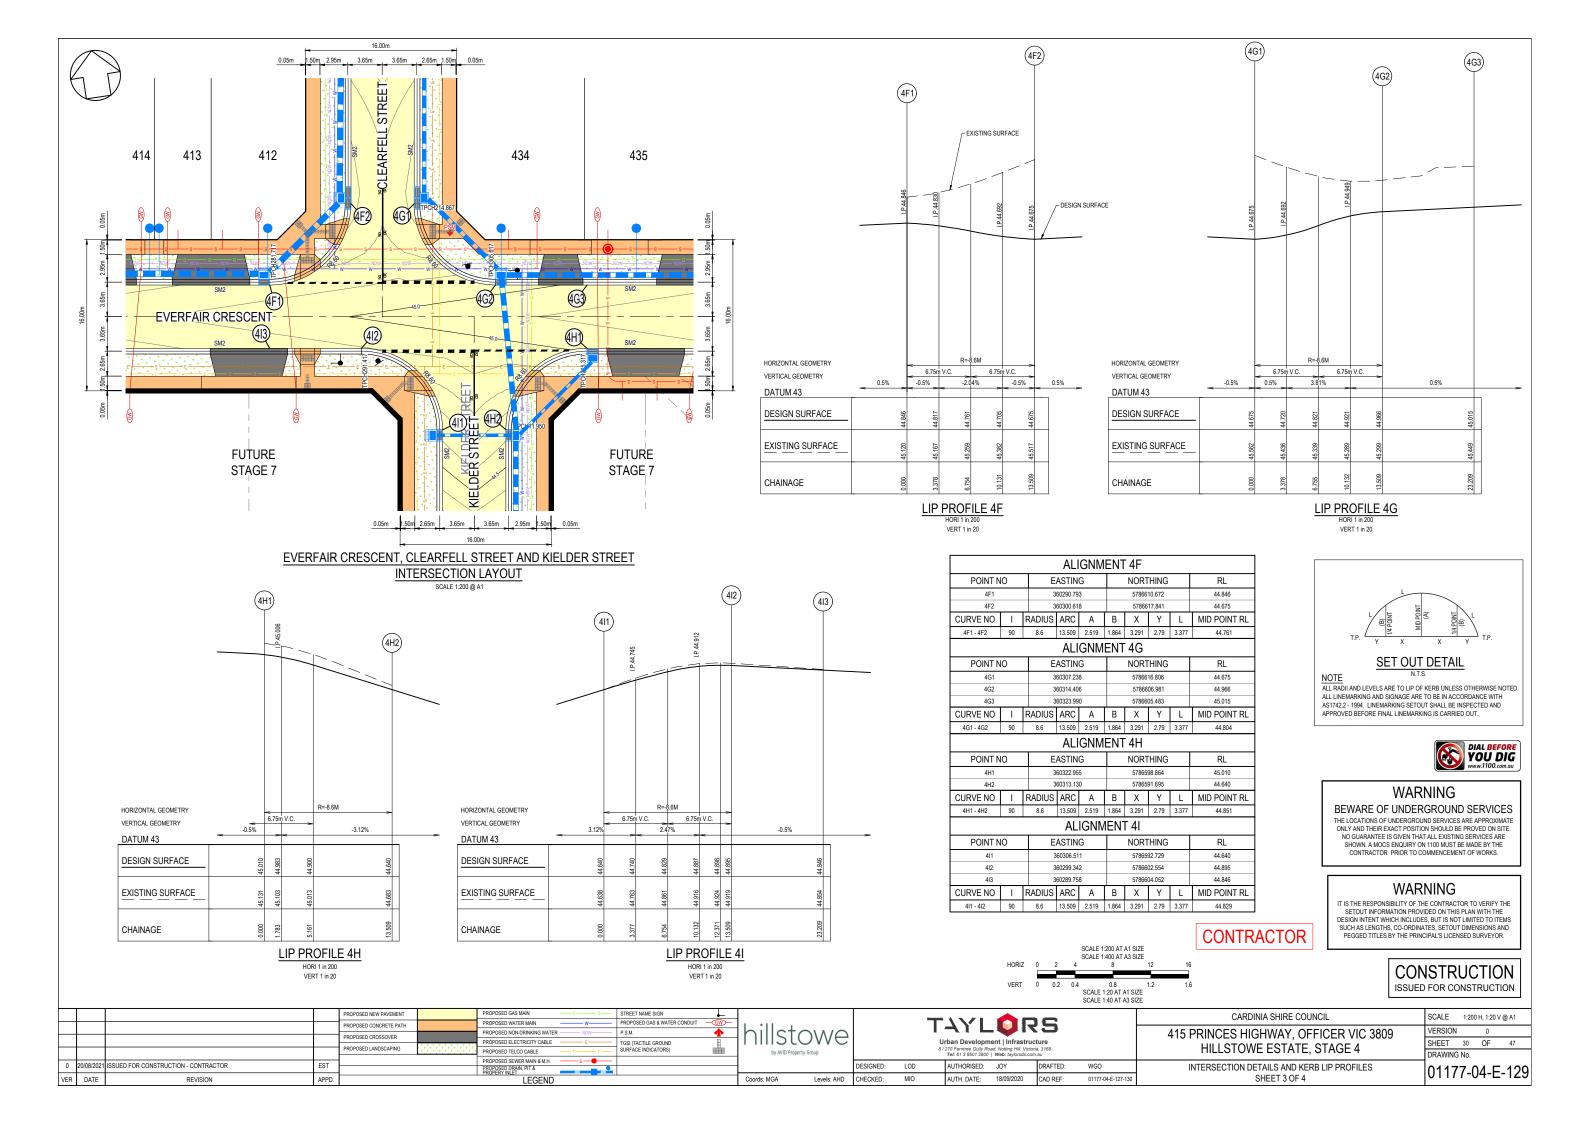

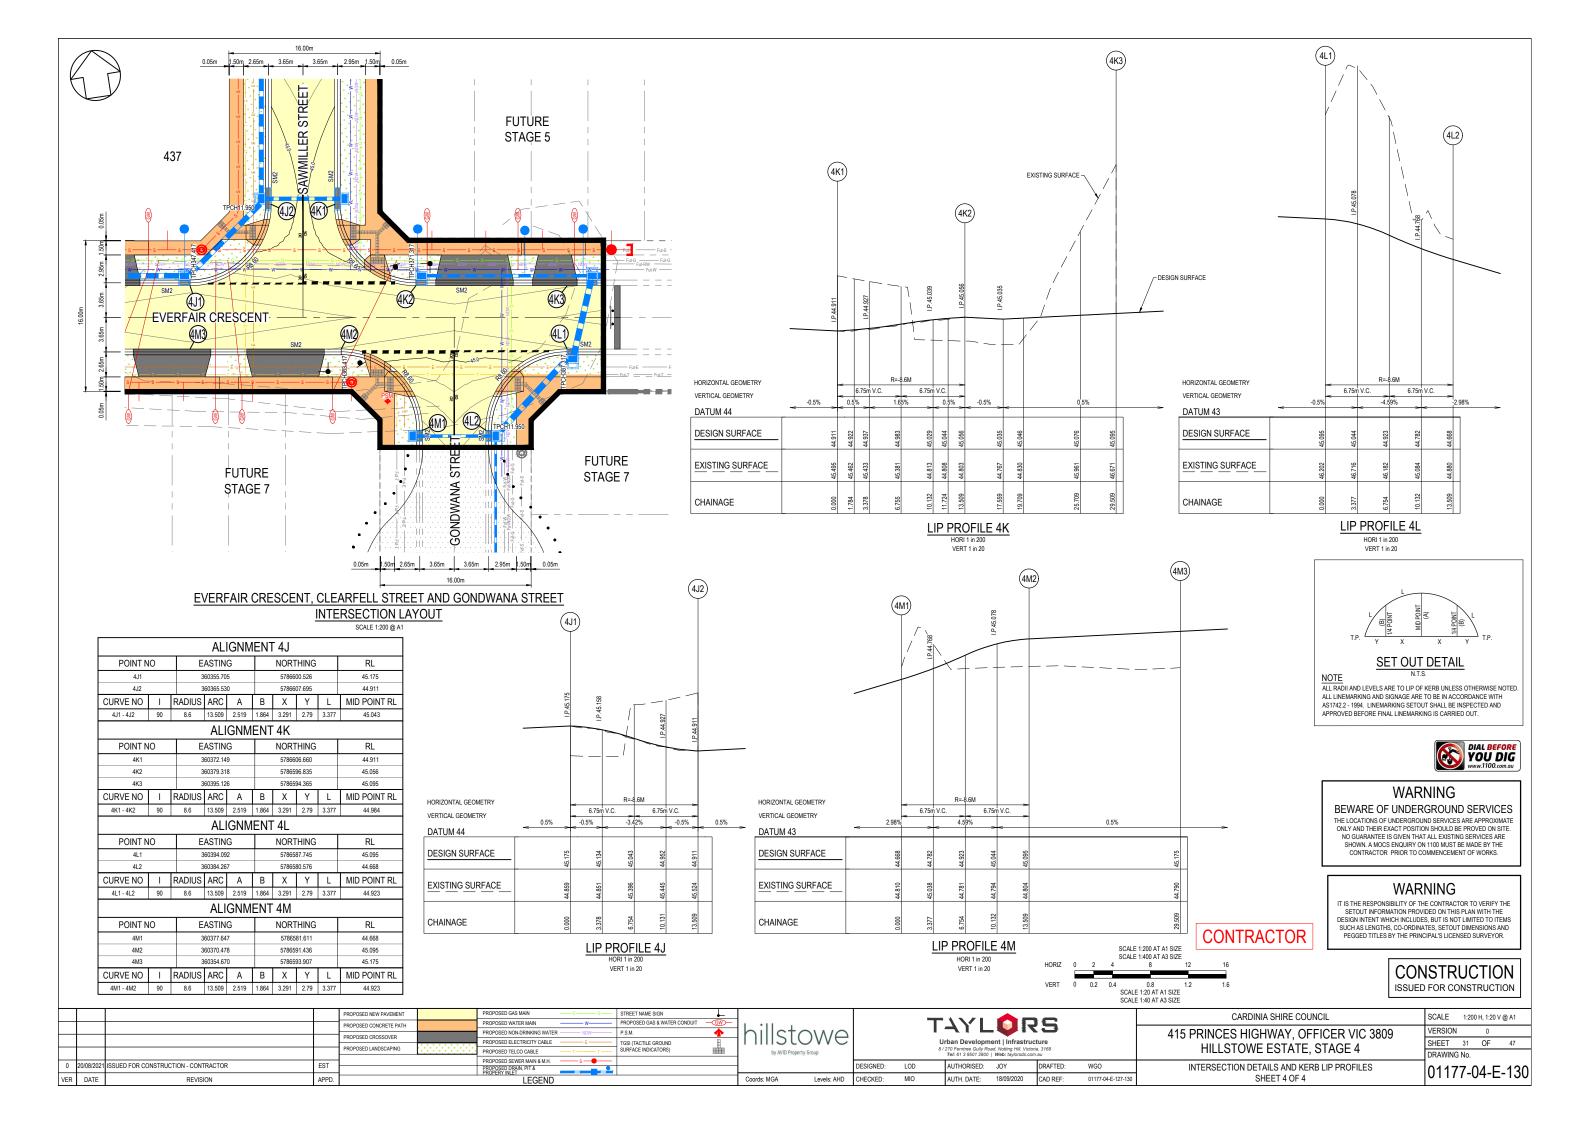

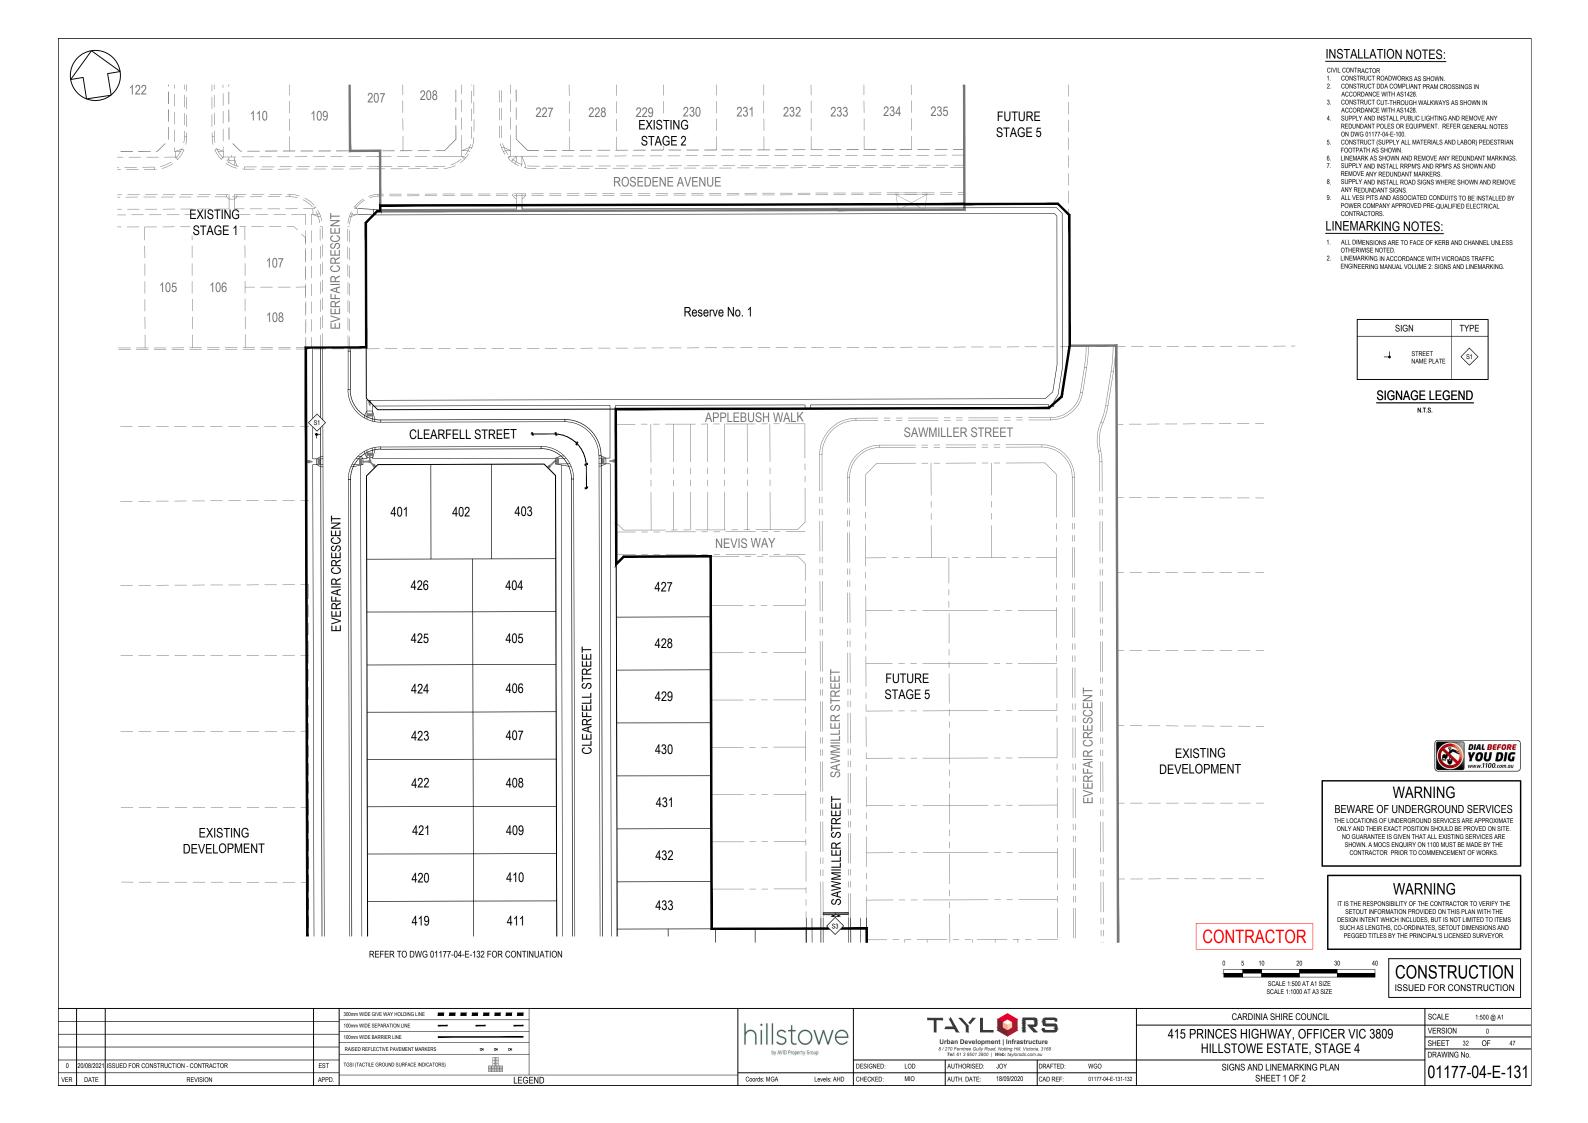

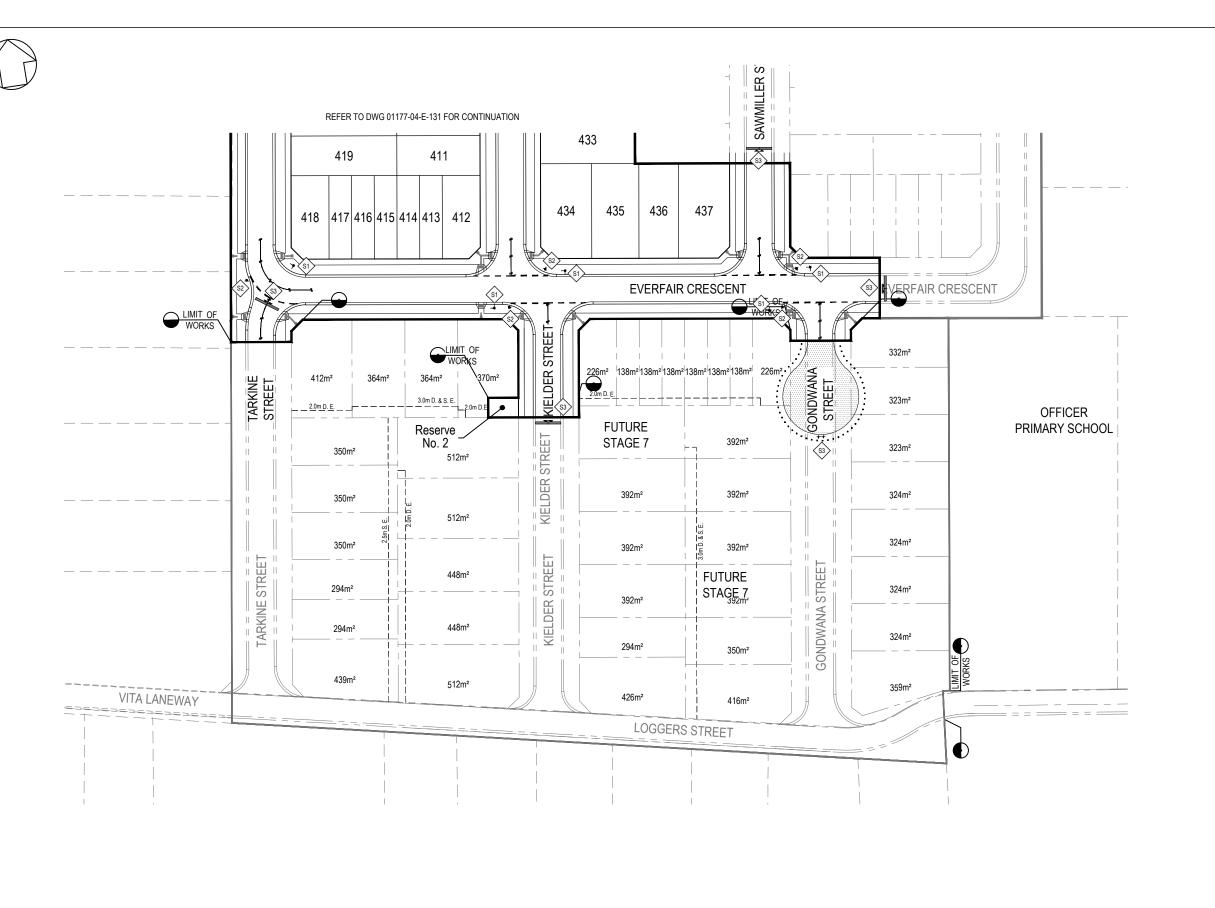

INSTALLATION NOTES:

- CIVIL CONTRACTOR

 1. CONSTRUCT DA COMPLIANT FRAM CROSSINGS IN ACCORDANCE WITH AS1428.

 3. CONSTRUCT OUT-THROUGH WALKWAYS AS SHOWN IN ACCORDANCE WITH AS1428.
- ACCORDANCE WITH AS1428.

 4. SUPPLY AND INSTALL PUBLIC LIGHTING AND REMOVE ANY REDUNDANT POLES OR EQUIPMENT. REFER GENERAL NOTES ON DWG 01177-04-E-100.

 5. CONSTRUCT (SUPPLY ALL MATERIALS AND LABOR) PEDESTRIAN FOOTPATH AS SHOWN.

 6. LINEMARK AS SHOWN AND REMOVE ANY REDUNDANT MARKINGS.

 7. SUPPLY AND INSTALL REPRIYS AND RPMS AS SHOWN AND REMOVE ANY REDUNDANT MARKERS.

 8. SUPPLY AND INSTALL RAPAN SIGNS WHIEDER SUCHMAN AND REMOVE ANY REDUNDANT MARKERS.

- NEMOVE ANY REDUNDANT MARKERS.
 SUPPLY AND INSTALL ROAD SIGNS WHERE SHOWN AND REMOVE
 ANY REDUNDANT SIGNS.
 ALL VESI PITS AND ASSOCIATED CONDUITS TO BE INSTALLED BY
 POWER COMPANY APPROVED PRE-QUALIFIED ELECTRICAL
 CONTRACTORS.

LINEMARKING NOTES:

- ALL DIMENSIONS ARE TO FACE OF KERB AND CHANNEL UNLESS OTHERWISE NOTED.
 LINEMARKING IN ACCORDANCE WITH VICROADS TRAFFIC ENGINEERING MANUAL VOLUME 2: SIGNS AND LINEMARKING.

SIG	TYPE	
4	⟨S1⟩	
GIVE	R1-2A	\(\sigma_2\)
NO ROAD	D4-5	\si

SIGNAGE LEGEND

N.T.S.



WARNING

BEWARE OF UNDERGROUND SERVICES

THE LOCATIONS OF UNDERGROUND SERVICES ARE APPROXIMATE ONLY AND THEIR EXACT POSITION SHOULD BE PROVED ON SITE. NO GUARANTEE IS GIVEN THAT ALL EXISTING SERVICES ARE SHOWN. A MOCS ENQUIRY ON 1100 MUST BE MADE BY THE CONTRACTOR PRIOR TO COMMENCEMENT OF WORKS.

WARNING

IT IS THE RESPONSIBILITY OF THE CONTRACTOR TO VERIFY THE SETOUT INFORMATION PROVIDED ON THIS PLAN WITH THE DESIGN INTENT WHICH INCLUDES, BUT IS NOT LIMITED TO ITEMS SUCH AS LENGTHS, CO-ORDINATES, SETOUT DIMENSIONS AND PEGGED TITLES BY THE PRINCIPAL'S LICENSED SURVEYOR.



CONSTRUCTION ISSUED FOR CONSTRUCTION

				300mm WIDE GIVE WAY HOLDING LINE	-
				100mm WIDE SEPARATION LINE	-
				100mm WIDE BARRIER LINE	-
				RAISED REFLECTIVE PAVEMENT MARKERS 0: 0: 0:	
0	20/08/2021	2021 ISSUED FOR CONSTRUCTION - CONTRACTOR		TGSI (TACTILE GROUND SURFACE INDICATORS)	
VED	DATE	DEVICION	ADDD	1,	CEN

hillstowe DESIGNED: LOD

Levels: AHD CHECKED:

Coords: MGA

T4YLORS AUTHORISED: JOY DRAFTED:

18/09/2020

CAD REF:

AUTH. DATE:

WGO


415 PRINCES HIGHWAY, OFFICER VIC 3809 HILLSTOWE ESTATE, STAGE 4

CONTRACTOR


SIGNS AND LINEMARKING PLAN SHEET 2 OF 2

CARDINIA SHIRE COUNCIL

SCALE 1:500 @ A1 VERSION SHEET 33 OF 47 DRAWING No.

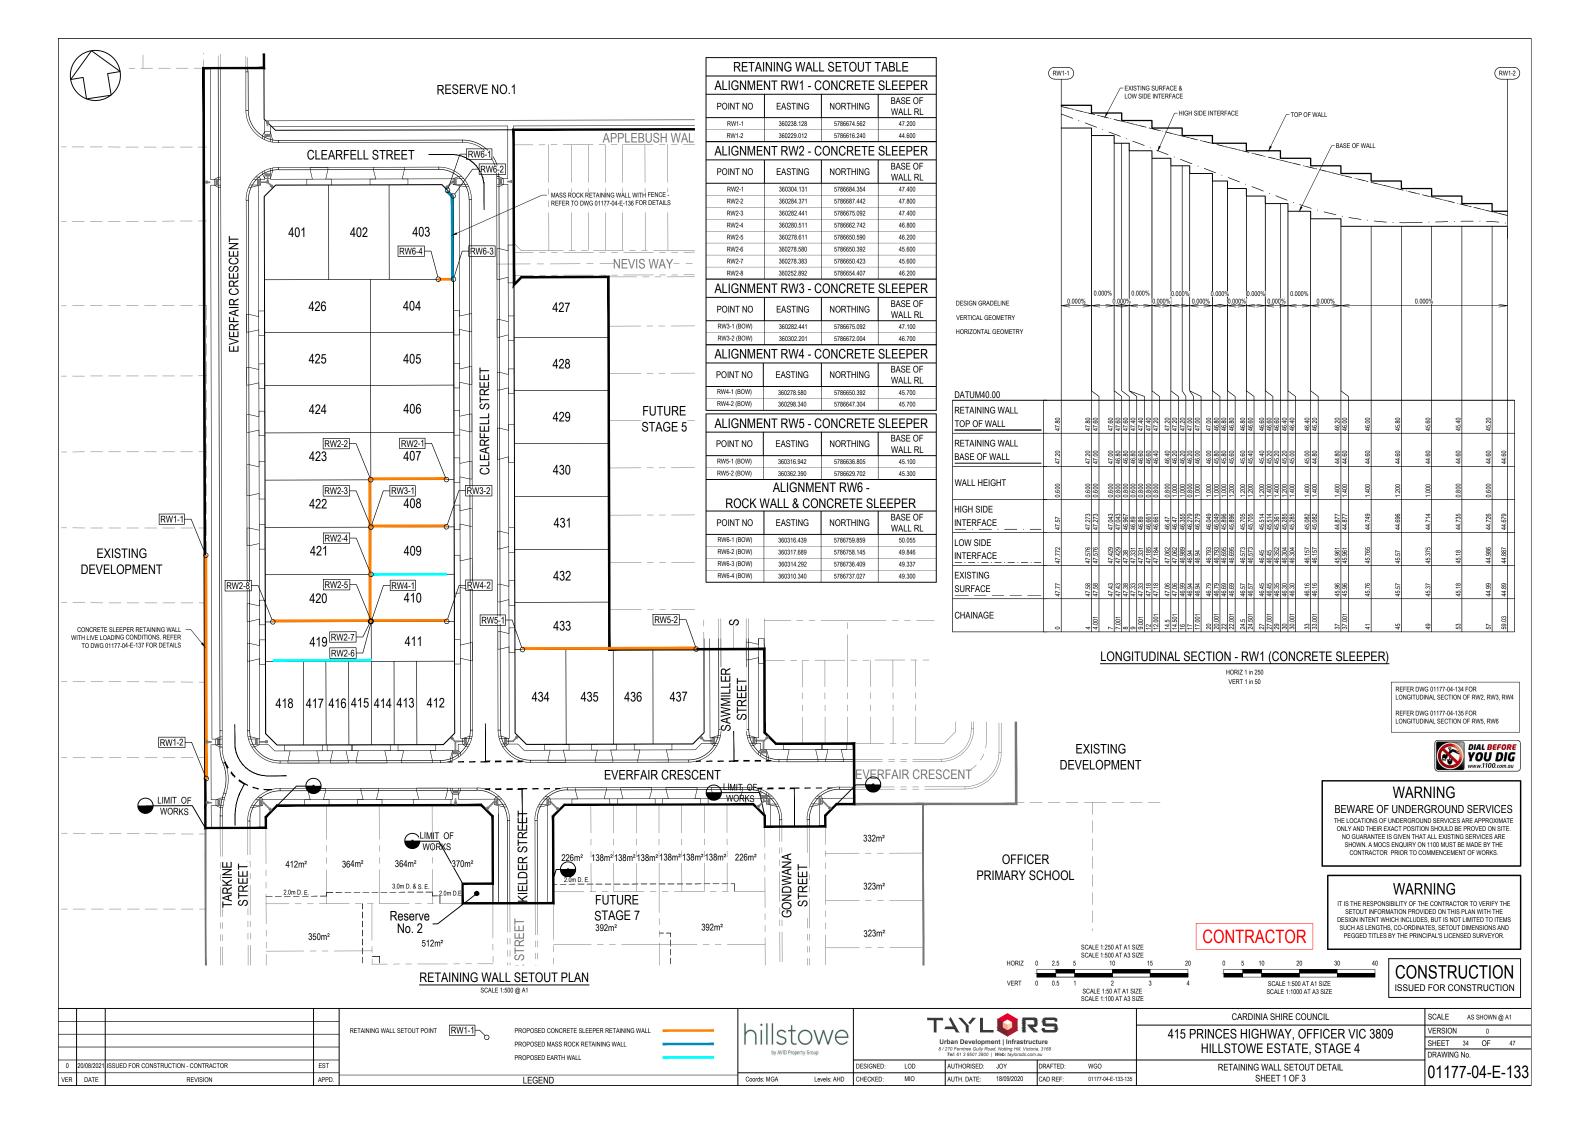

REFER DWG 01177-04-E-133 FOR SETOUT OF ALIGNMENTS RW2, RW3, RW4

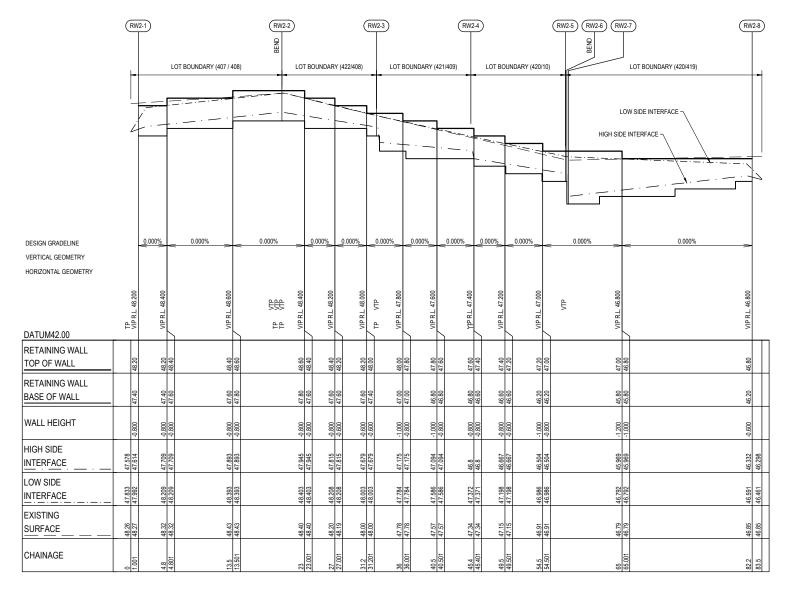

(RW3-1) (RW3-2) TOP OF WALL - BASE OF WALL 0.000% 0.000% DESIGN GRADELINE VERTICAL GEOMETRY HORIZONTAL GEOMETRY DATUM43.00 RETAINING WALL TOP OF WALL RETAINING WALL BASE OF WALL WALL HEIGHT HIGH SIDE INTERFACE LOW SIDE INTERFACE EXISTING SURFACE CHAINAGE

(RW4-1) (RW4-2) - EXISTING SURFACE 0.000% DESIGN GRADELINE VERTICAL GEOMETRY HORIZONTAL GEOMETRY DATUM41.00 RETAINING WALL TOP OF WALL RETAINING WALL BASE OF WALL WALL HEIGHT HIGH SIDE INTERFACE LOW SIDE INTERFACE EXISTING SURFACE CHAINAGE

LONGITUDINAL SECTION - RW2 (CONCRETE SLEEPER)

HORIZ 1 in 250

LONGITUDINAL SECTION - RW3 (CONCRETE SLEEPER)

HORIZ 1 in 250 VERT 1 in 50

SCALE 1:250 AT A1 SIZE SCALE 1:500 AT A3 SIZE

SCALE 1:50 AT A1 SIZE SCALE 1:100 AT A3 SIZE

WGO

CAD REF:

LONGITUDINAL SECTION - RW4 (CONCRETE SLEEPER)

HORIZ 1 in 250



WARNING

BEWARE OF UNDERGROUND SERVICES

THE LOCATIONS OF UNDERGROUND SERVICES ARE APPROXIMATE ONLY AND THEIR EXACT POSITION SHOULD BE PROVED ON SITE. NO GUARANTEE IS GIVEN THAT ALL EXISTING SERVICES ARE SHOWN, A MOCS ENQUIRY ON 1100 MUST BE MADE BY THE CONTRACTOR PRIOR TO COMMENCEMENT OF WORKS.

WARNING

IT IS THE RESPONSIBILITY OF THE CONTRACTOR TO VERIFY THE SETOUT INFORMATION PROVIDED ON THIS PLAN WITH THE DESIGN INTENT WHICH INCLUDES. BUT IS NOT LIMITED TO ITEMS SUCH AS LENGTHS. CO-ORDINATES. SETOUT DIMENSIONS AND PEGGED TITLES BY THE PRINCIPAL'S LICENSED SURVEYOR.

> CONSTRUCTION ISSUED FOR CONSTRUCTION

0	20/08/2021	ISSUED FOR CONSTRUCTION - CONTRACTOR	EST
VER	DATE	REVISION	ΔPPD

hillstowe Levels: AHD CHECKED:

T4YLORS DESIGNED: LOD AUTHORISED: JOY DRAFTED:

AUTH. DATE: 18/09/2020

HORIZ

VFRT

CARDINIA SHIRE COUNCIL 415 PRINCES HIGHWAY, OFFICER VIC 3809 HILLSTOWE ESTATE. STAGE 4

CONTRACTOR


VERSION SHEET 35 OF 47 DRAWING No.

RETAINING WALL SETOUT DETAIL SHEET 2 OF 3

01177-04-E-134


SCALE AS SHOWN @ A1

REFER DWG 01177-04-E-133 FOR SETOUT OF ALIGNMENTS RW5, RW6

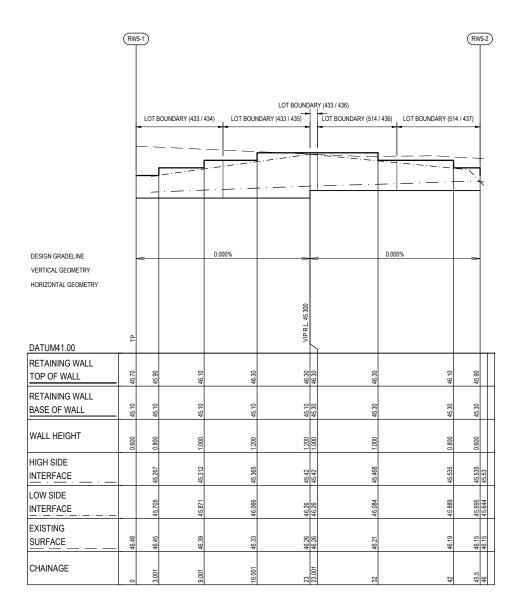

LONGITUDINAL SECTION - RW5 (CONCRETE SLEEPER)

HORIZ 1 in 250 VERT 1 in 50

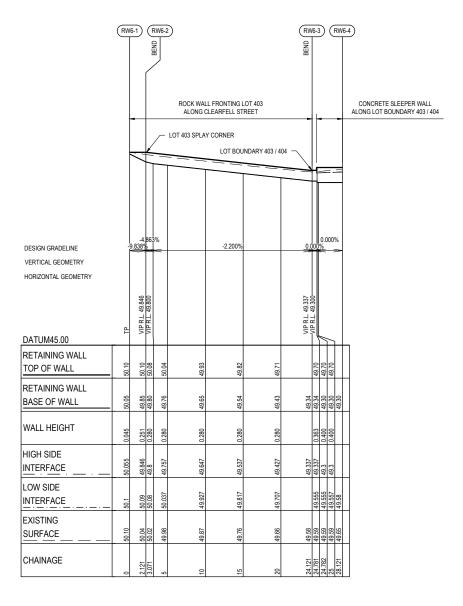

LONGITUDINAL SECTION - RW6 (ROCK WALL & CONCRETE SLEEPER)

HORIZ 1 in 250 VERT 1 in 50

> SCALE 1:250 AT A1 SIZE SCALE 1:500 AT A3 SIZE

SCALE 1:50 AT A1 SIZE SCALE 1:100 AT A3 SIZE



WARNING

BEWARE OF UNDERGROUND SERVICES

THE LOCATIONS OF UNDERGROUND SERVICES ARE APPROXIMATE ONLY AND THEIR EXACT POSITION SHOULD BE PROVED ON SITE. NO GUARANTEE IS GIVEN THALL EXISTING SERVICES ARE SHOWN. A MOCS ENQUIRY ON 1100 MUST BE MADE BY THE CONTRACTOR PRIOR TO COMMENCEMENT OF WORKS.

WARNING

IT IS THE RESPONSIBILITY OF THE CONTRACTOR TO VERIFY THE SETOUT INFORMATION PROVIDED ON THIS PLAN WITH THE DESIGN INTENT WHICH INCLUDES, BUT IS NOT LIMITED TO ITEMS SUCH AS LENGTHS, CO-ORDINATES, SETOUT DIMENSIONS AND PEGGED TITLES BY THE PRINCIPAL'S LICENSED SURVEYOR.

CONSTRUCTION ISSUED FOR CONSTRUCTION

SCALE

0	20/08/2021	ISSUED FOR CONSTRUCTION - CONTRACTOR	EST
VFR	DATE	REVISION	APPD.

hillstowe
by AVID Property Group
DESIGNED:
Coords: MGA Levels: AHD CHECKED:

Urban Development | Infrastructure
8 / 2776 Ferniree Gully Road, Noting Hill, Victoria, 3188
Tel: 61 3 9507 2000 | Web: Explorads.com.au

DESIGNED: LOD AUTHORISED: JOY DRAFTED: WGO

AUTH. DATE: 18/09/2020 CAD REF:

HORIZ

VERT

CARDINIA SHIRE COUNCIL


415 PRINCES HIGHWAY, OFFICER VIC 3809
HILLSTOWE ESTATE, STAGE 4


CONTRACTOR

აისყ				
0000	SHEET	36	0	
	DRAWING	3 No.		
	0117	77 (۱/	

RETAINING WALL SETOUT DETAIL SHEET 3 OF 3 01177-04-E-135

AS SHOWN @ A1

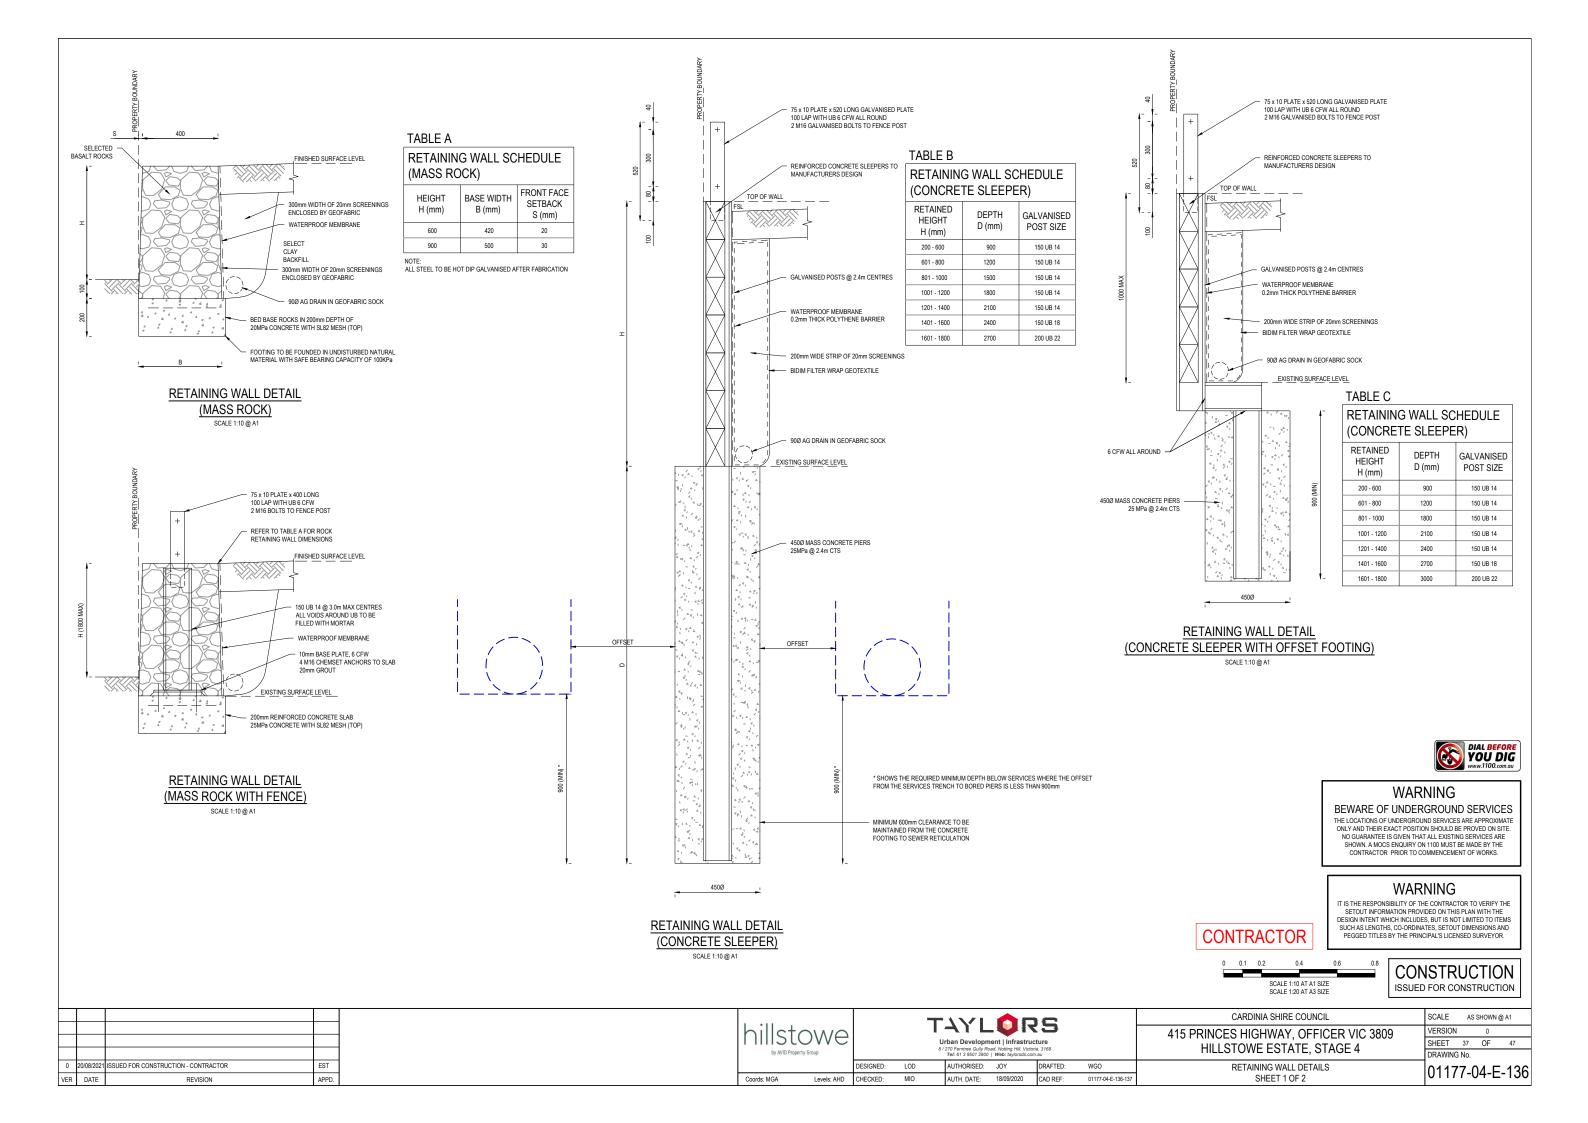

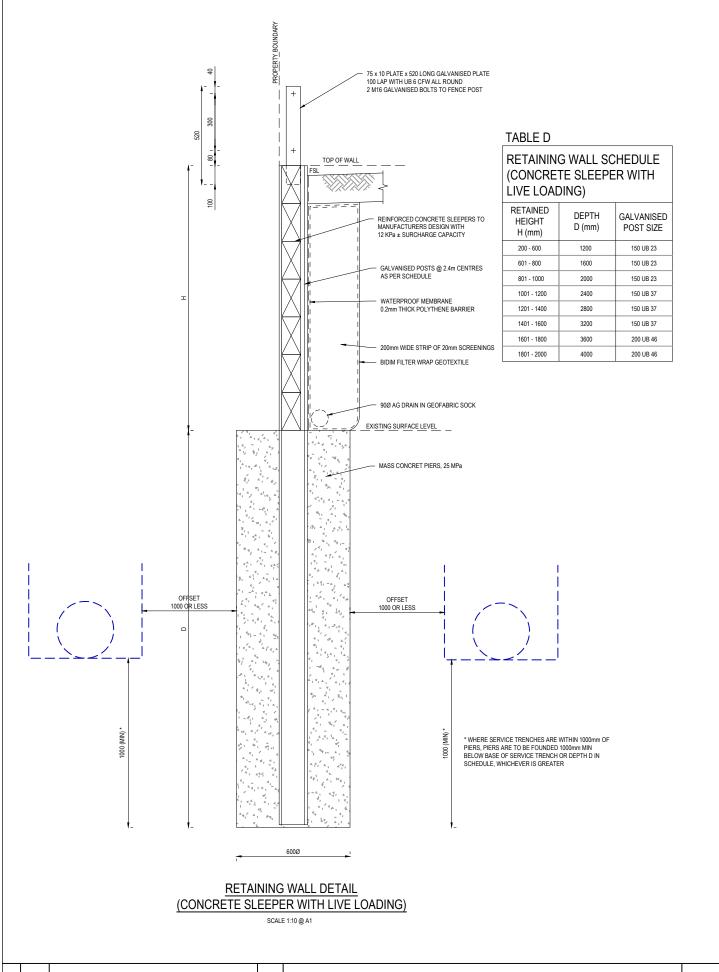


0 20/08/2021 ISSUED FOR CONSTRUCTION - CONTRACTOR

REVISION

VER DATE

EST

APPD.

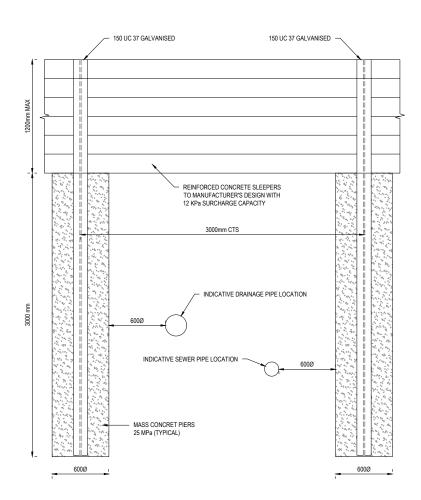

RETAINING WALL DETAIL (CONCRETE SLEEPER WITH 3m SPAN)

SCALE 1:20 @ A1



WARNING

BEWARE OF UNDERGROUND SERVICES

THE LOCATIONS OF UNDERGROUND SERVICES ARE APPROXIMATE ONLY AND THEIR EXACT POSITION SHOULD BE PROVED ON SITE. NO GUARANTEE IS GIVEN THALL EXISTING SERVICES ARE SHOWN. A MOCS ENQUIRY ON 1100 MUST BE MADE BY THE CONTRACTOR PRIOR TO COMMENCEMENT OF WORKS.

WARNING

IT IS THE RESPONSIBILITY OF THE CONTRACTOR TO VERIFY THE SETOUT INFORMATION PROVIDED ON THIS PLAN WITH THE DESIGN INTENT WHICH INCLUDES, BUT IS NOT LIMITED TO ITEMS SUCH AS LENGTHS, CO-ODINATES, SETOUT DIMENSIONS AND PEGGED TITLES BY THE PRINCIPAL'S LICENSED SURVEYOR.

SCALE 1:10 AT A1 SIZE SCALE 1:20 AT A3 SIZE

CONSTRUCTION ISSUED FOR CONSTRUCTION

YI A RS	
(415 F
in Develonment Infrastructure	_

CARDINIA SHIRE COUNCIL PRINCES HIGHWAY, OFFICER VIC 3809 HILLSTOWE ESTATE, STAGE 4

CONTRACTOR

SCALE AS SHOWN @ A1 VERSION SHEET 38 OF 47 DRAWING No.

RETAINING WALL DETAILS SHEET 2 OF 2


01177-04-E-137


hillstowe


Coords: MGA

AUTHORISED: JOY

DESIGNED: LOD DRAFTED: WGO AUTH. DATE: 18/09/2020 Levels: AHD CHECKED:

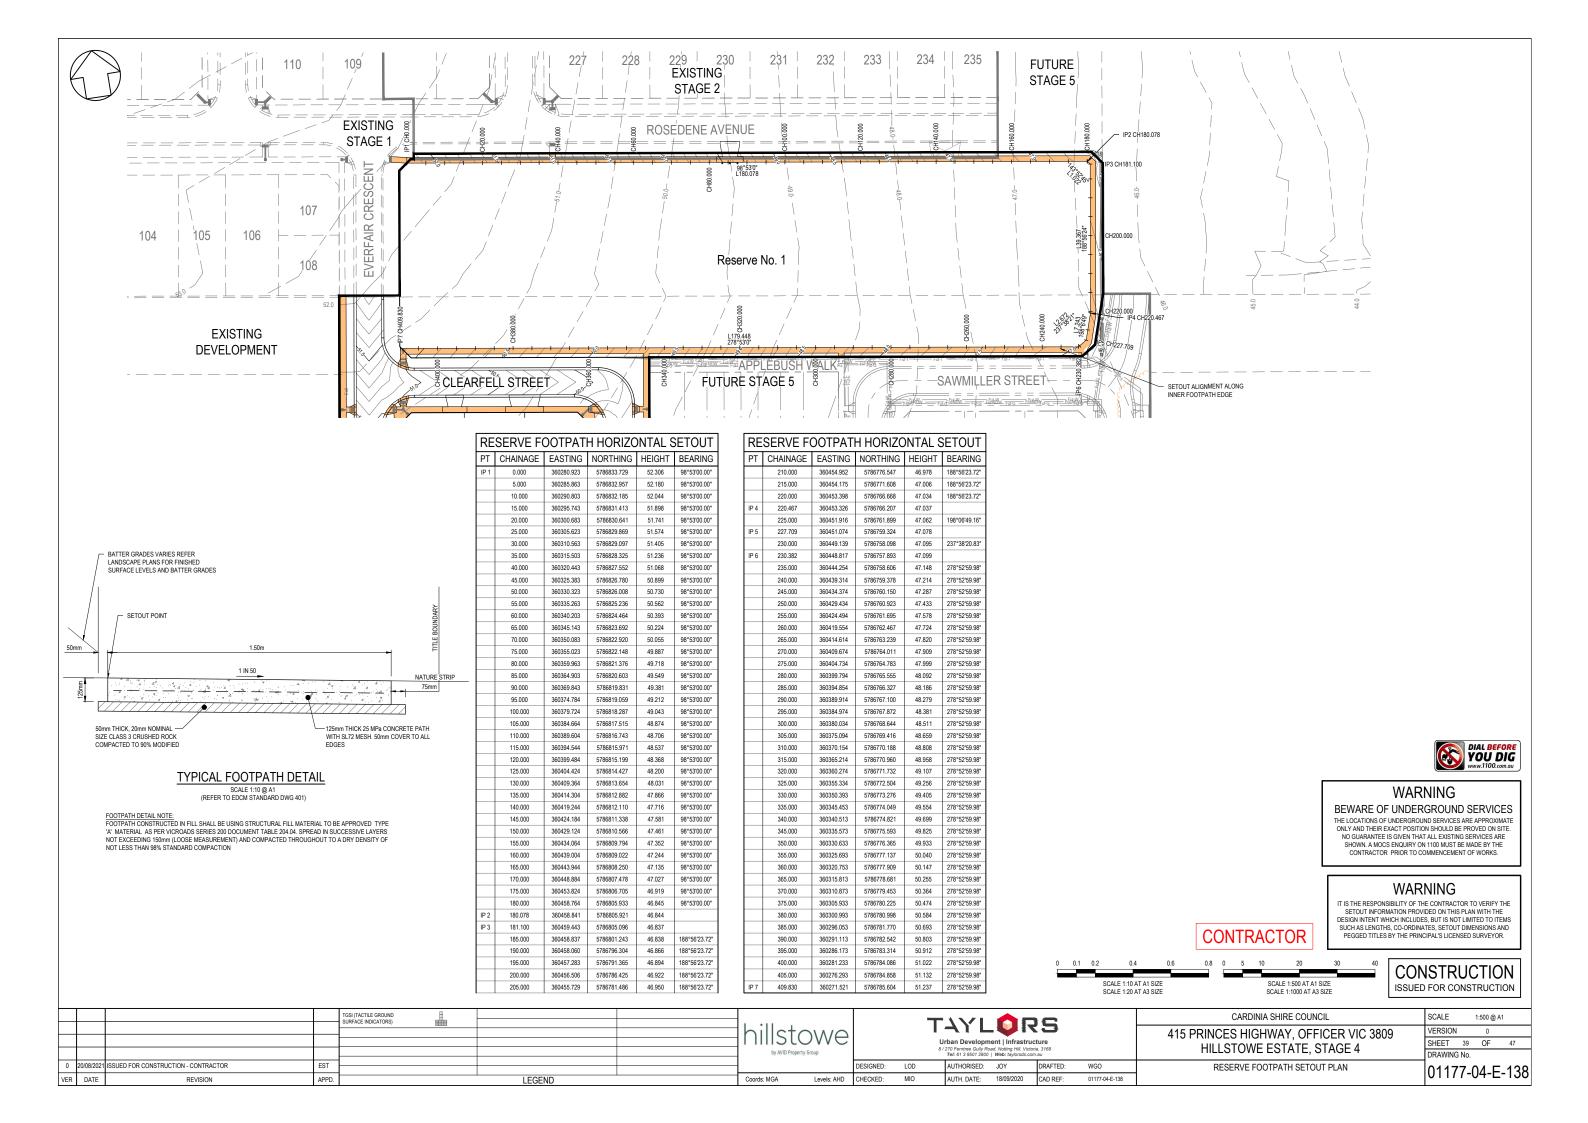

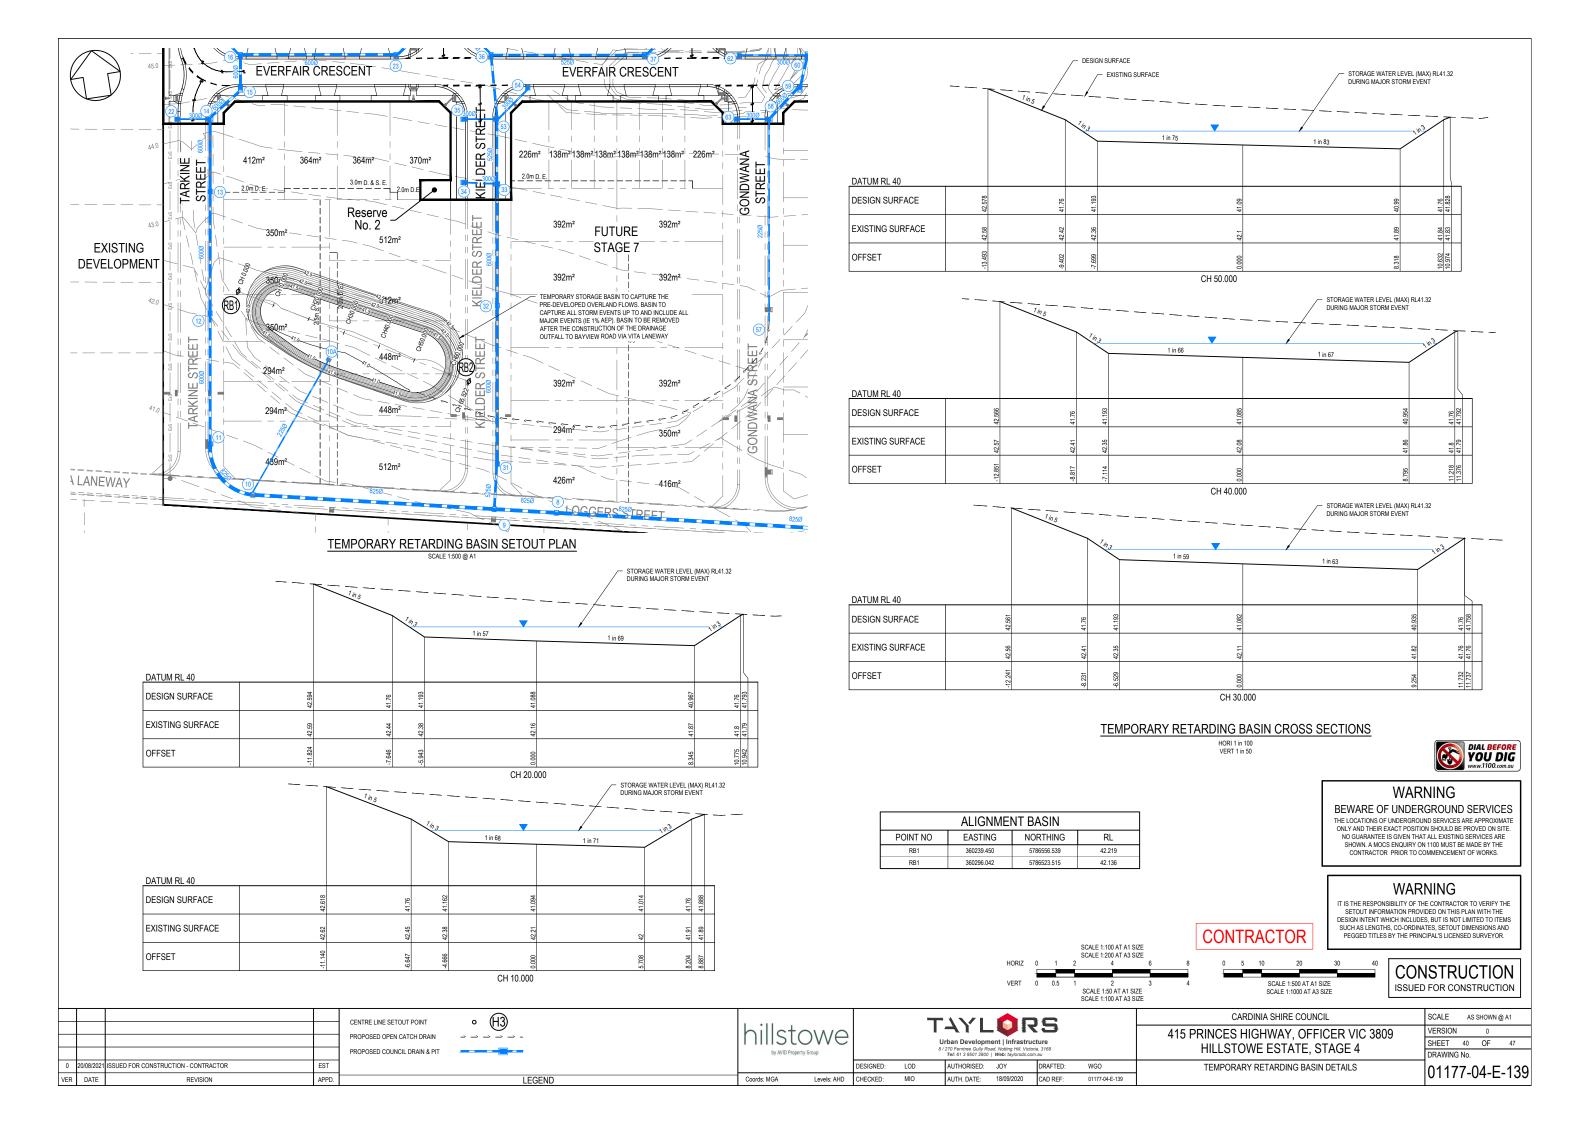

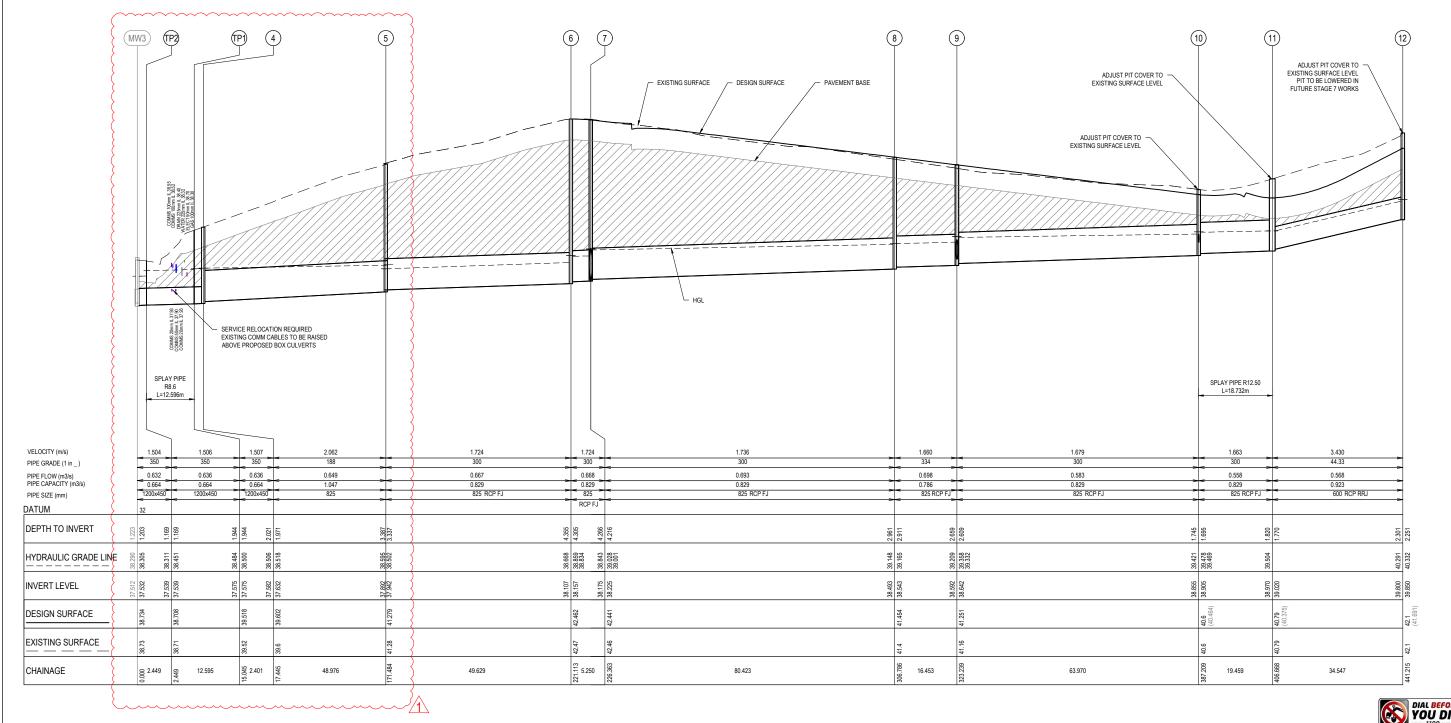



SCALE 1:500 AT A1 SIZE SCALE 1:1000 AT A3 SIZE

SCALE 1:50 AT A1 SIZE SCALE 1:100 AT A3 SIZE

PIPE CLASS TO BE CLASS 2 UNLESS NOTED OTHERWISE.
 STRUCTURAL FILL USED ONLY WHEN EXISTING SURFACE IS BELOW FOOTPATH.

WARNING

BEWARE OF UNDERGROUND SERVICES

THE LOCATIONS OF UNDERGROUND SERVICES ARE APPROXIMATE ONLY AND THEIR EXACT POSITION SHOULD BE PROVED ON SITE. NO GUARANTEE IS GIVEN THALL EXISTING SERVICES ARE SHOWN. A MOCS ENQUIRY ON 1100 MUST BE MADE BY THE CONTRACTOR PRIOR TO COMMENCEMENT OF WORKS.

WARNING

IT IS THE RESPONSIBILITY OF THE CONTRACTOR TO VERIFY THE SETOUT INFORMATION PROVIDED ON THIS PLAN WITH THE DESIGN INTENT WHICH INCLUDES, BUT IS NOT LIMITED TO ITEMS SUCH AS LENGTHS, CO-ODINATES, SETOUT DIMENSIONS AND PEGGED TITLES BY THE PRINCIPAL'S LICENSED SURVEYOR.

> CONSTRUCTION ISSUED FOR CONSTRUCTION

				;
1	07/09/2021	MINOR AMENDMENT TO OUTFALL DRAIN	EST	ľ
0	20/08/2021	ISSUED FOR CONSTRUCTION - CONTRACTOR	EST	
VER	DATE	REVISION	APPD.	

LEGEND DENOTES 20mm CLASS 2 FCR BACKFILL hillstowe DESIGNED: LOD Coords: MGA Levels: AHD CHECKED:

T4YLORS AUTHORISED: JOY DRAFTED: WGO AUTH. DATE: 18/09/2020

CAD REF:


HORIZ

CARDINIA SHIRE COUNCIL 415 PRINCES HIGHWAY, OFFICER VIC 3809 HILLSTOWE ESTATE, STAGE 4

CONTRACTOR

0117		04-F	-140
DRAWING	No.		
SHEET	41	OF	47
VERSION		1	
SCALE	1:50	0 H, 1:50 V	/ @ A1

DRAINAGE LONGITUDINAL SECTIONS SHEET 1 OF 6

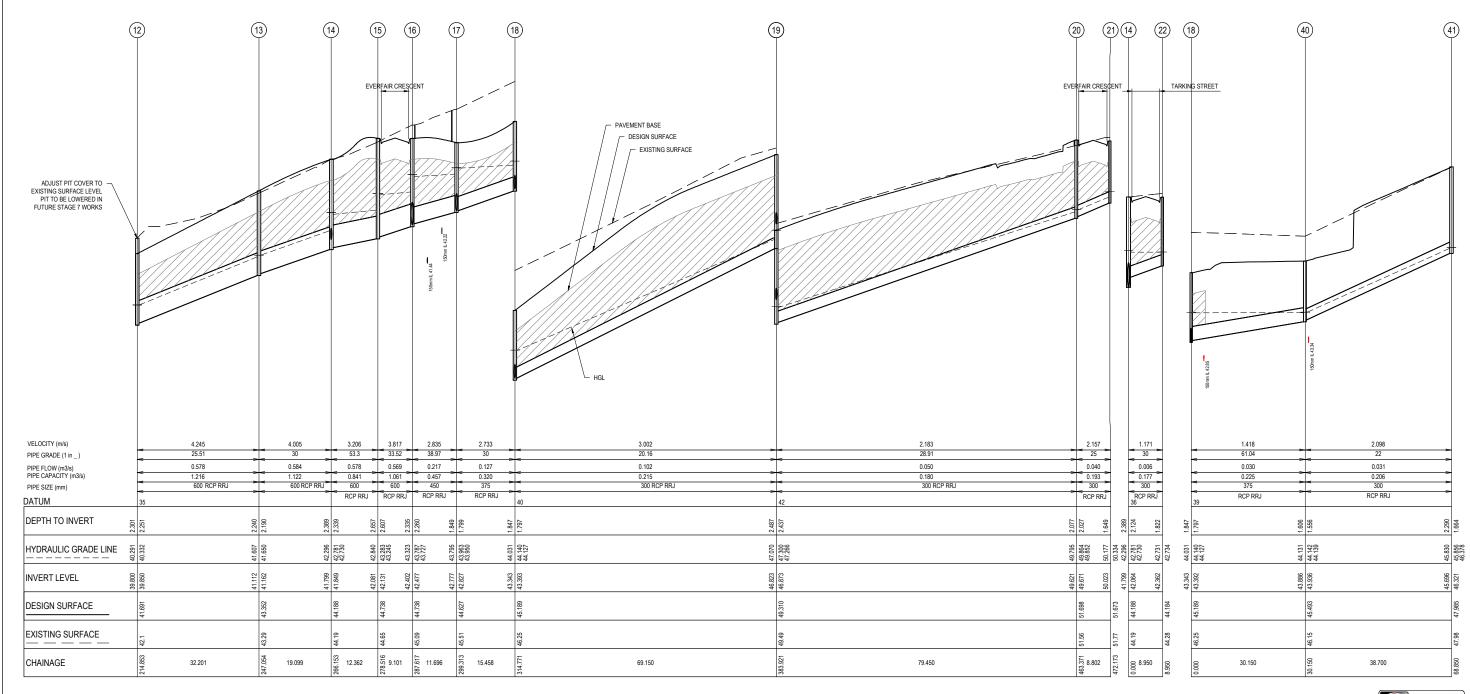



SCALE 1:500 AT A1 SIZE SCALE 1:1000 AT A3 SIZE

1 2 SCALE 1:50 AT A1 SIZE SCALE 1:100 AT A3 SIZE

WGO

- PIPE CLASS TO BE CLASS 2 UNLESS NOTED OTHERWISE.
 STRUCTURAL FILL USED ONLY WHEN EXISTING SURFACE IS BELOW FOOTPATH.

WARNING

BEWARE OF UNDERGROUND SERVICES

THE LOCATIONS OF UNDERGROUND SERVICES ARE APPROXIMATE ONLY AND THEIR EXACT POSITION SHOULD BE PROVED ON SITE. NO GUARANTEE IS GIVEN THAT ALL EXISTING SERVICES ARE SHOWN. A MOCS ENQUIRY ON 1100 MUST BE MADE BY THE CONTRACTOR PRIOR TO COMMENCEMENT OF WORKS.

WARNING

IT IS THE RESPONSIBILITY OF THE CONTRACTOR TO VERIFY THE SETOUT INFORMATION PROVIDED ON THIS PLAN WITH THE DESIGN INTENT WHICH INCLUDES, BUT IS NOT LIMITED TO ITEMS SUCH AS LENGTHS, CO-ODINATES, SETOUT DIMENSIONS AND PEGGED TITLES BY THE PRINCIPAL'S LICENSED SURVEYOR.

> CONSTRUCTION ISSUED FOR CONSTRUCTION

				LEGE
0	20/08/2021	ISSUED FOR CONSTRUCTION - CONTRACTOR	EST	

REVISION

VER DATE

END DENOTES 20mm CLASS 2 FCR BACKFILL APPD.

hillstowe DESIGNED: LOD Levels: AHD CHECKED:

T4YLORS AUTHORISED: JOY DRAFTED:

AUTH. DATE: 18/09/2020 CAD REF:


HORIZ

CARDINIA SHIRE COUNCIL 415 PRINCES HIGHWAY, OFFICER VIC 3809 HILLSTOWE ESTATE, STAGE 4

CONTRACTOR

SCALE	1:50	0 H, 1:50 V	@
VERSION		0	
SHEET	42	OF	
DRAWING	No.		

DRAINAGE LONGITUDINAL SECTIONS SHEET 2 OF 6

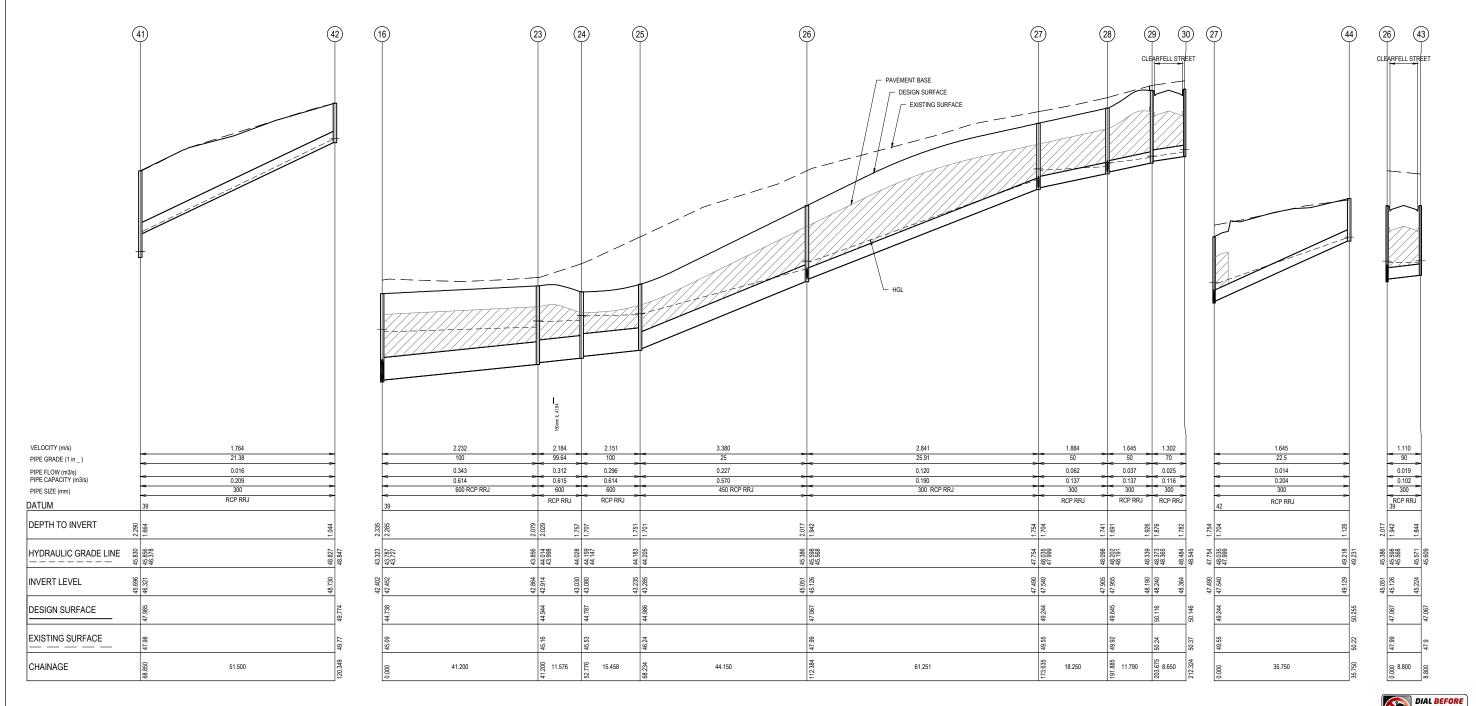



SCALE 1:500 AT A1 SIZE SCALE 1:1000 AT A3 SIZE

2 SCALE 1:50 AT A1 SIZE SCALE 1:100 AT A3 SIZE

- PIPE CLASS TO BE CLASS 2 UNLESS NOTED OTHERWISE.
 STRUCTURAL FILL USED ONLY WHEN EXISTING SURFACE IS BELOW FOOTPATH.

DIAL BEFORE YOU DIG WWW.1100.com.au

WARNING

BEWARE OF UNDERGROUND SERVICES

THE LOCATIONS OF UNDERGROUND SERVICES ARE APPROXIMATE ONLY AND THEIR EXACT POSITION SHOULD BE PROVED ON SITE. NO GUARANTEE IS GIVEN THALL EXISTING SERVICES ARE SHOWN. A MOCS ENQUIRY ON 1100 MUST BE MADE BY THE CONTRACTOR PRIOR TO COMMENCEMENT OF WORKS.

WARNING

IT IS THE RESPONSIBILITY OF THE CONTRACTOR TO VERIFY THE SETOUT INFORMATION PROVIDED ON THIS PLAN WITH THE DESIGN INTENT WHICH INCLUDES, BUT IS NOT LIMITED TO ITEMS SUCH AS LENGTHS, CO-ODINATES, SETOUT DIMENSIONS AND PEGGED TITLES BY THE PRINCIPAL'S LICENSED SURVEYOR.

CONSTRUCTION ISSUED FOR CONSTRUCTION

0	20/08/2021	ISSUED FOR CONSTRUCTION - CONTRACTOR	EST
VER	DATE	REVISION	APPD.

LEGEND DENOTES 20mm CLASS 2 FCR BACKFILL

hillstowe DESIGNED: LOD Levels: AHD CHECKED:

T4YLORS AUTHORISED: JOY DRAFTED: WGO


AUTH. DATE: 18/09/2020 CAD REF:

CARDINIA SHIRE COUNCIL 415 PRINCES HIGHWAY, OFFICER VIC 3809 HILLSTOWE ESTATE, STAGE 4

CONTRACTOR

SCALE	1:50	00 H, 1:50 V	@ A1
VERSION		0	
SHEET	43	OF	47
DRAWING	No.		

DRAINAGE LONGITUDINAL SECTIONS SHEET 3 OF 6

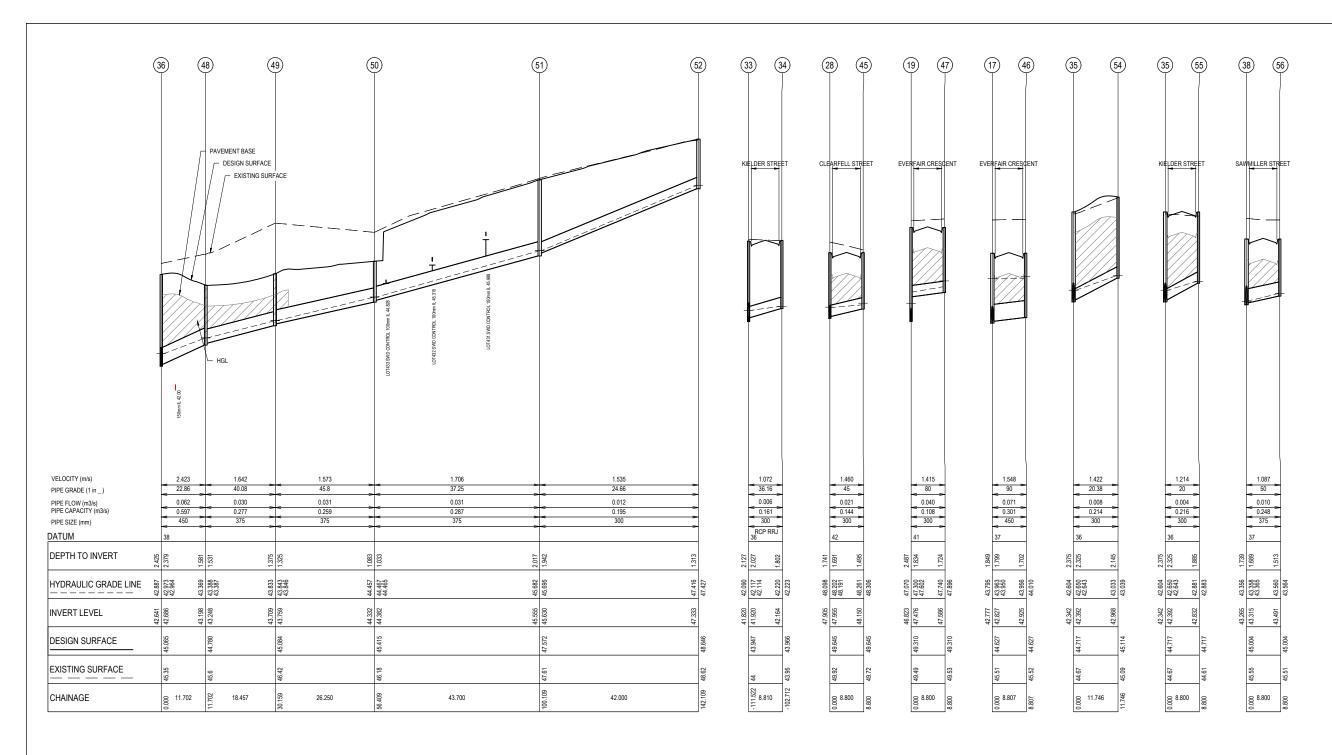



SCALE 1:500 AT A1 SIZE SCALE 1:1000 AT A3 SIZE

SCALE 1:50 AT A1 SIZE SCALE 1:100 AT A3 SIZE

WGO

- PIPE CLASS TO BE CLASS 2 UNLESS NOTED OTHERWISE.
 STRUCTURAL FILL USED ONLY WHEN EXISTING SURFACE IS BELOW FOOTPATH.

WARNING

BEWARE OF UNDERGROUND SERVICES

THE LOCATIONS OF UNDERGROUND SERVICES ARE APPROXIMATE ONLY AND THEIR EXACT POSITION SHOULD BE PROVED ON SITE. NO GUARANTEE IS GIVEN THAT ALL EXISTING SERVICES ARE SHOWN. A MOCS ENQUIRY ON 1100 MUST BE MADE BY THE CONTRACTOR PRIOR TO COMMENCEMENT OF WORKS.

WARNING

IT IS THE RESPONSIBILITY OF THE CONTRACTOR TO VERIFY THE SETOUT INFORMATION PROVIDED ON THIS PLAN WITH THE DESIGN INTENT WHICH INCLUDES, BUT IS NOT LIMITED TO ITEMS SUCH AS LENGTHS, CO-ODINATES, SETOUT DIMENSIONS AND PEGGED TITLES BY THE PRINCIPAL'S LICENSED SURVEYOR.

> CONSTRUCTION ISSUED FOR CONSTRUCTION

0 20/08/2021 ISSUED FOR CONSTRUCTION - CONTRACTOR EST VER DATE APPD. REVISION

LEGEND DENOTES 20mm CLASS 2 FCR BACKFILL

hillstowe Coords: MGA Levels: AHD CHECKED:

T4YLORS DESIGNED: LOD AUTHORISED: JOY DRAFTED:

AUTH. DATE: 18/09/2020 CAD REF:


HORIZ

CARDINIA SHIRE COUNCIL 415 PRINCES HIGHWAY, OFFICER VIC 3809 HILLSTOWE ESTATE, STAGE 4

CONTRACTOR

DRAINAGE LONGITUDINAL SECTIONS SHEET 4 OF 6

SCALE	1:50	0 H, 1:50 V	/ @ A1
VERSION		0	
SHEET	44	OF	47
DRAWING	No.		
0117	7-()4-E	-143

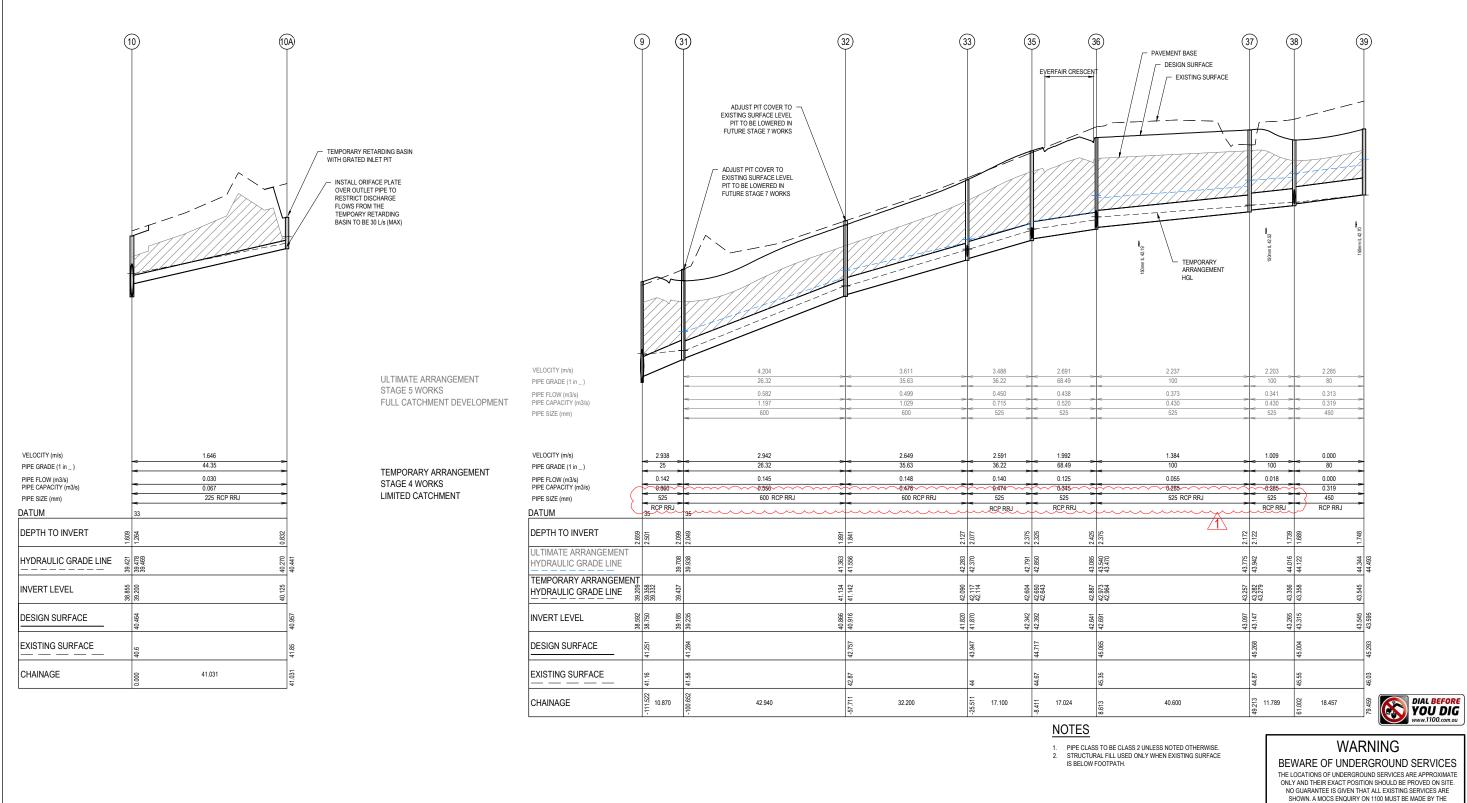

BEWARE OF UNDERGROUND SERVICES

THE LOCATIONS OF UNDERGROUND SERVICES ARE APPROXIMATE ONLY AND THEIR EXACT POSITION SHOULD BE PROVED ON SITE. NO GUARANTEE IS GIVEN THAT ALL EXISTING SERVICES ARE SHOWN, A MOCS ENQUIRY ON 1100 MUST BE MADE BY THE CONTRACTOR PRIOR TO COMMENCEMENT OF WORKS.

WARNING

IT IS THE RESPONSIBILITY OF THE CONTRACTOR TO VERIFY THE SETOUT INFORMATION PROVIDED ON THIS PLAN WITH THE DESIGN INTENT WHICH INCLUDES, BUT IS NOT LIMITED TO ITEMS SUCH AS LENGTHS, CO-ORDINATES, SETOUT DIMENSIONS AND PEGGED TITLES BY THE PRINCIPAL'S LICENSED SURVEYOR.

> CONSTRUCTION ISSUED FOR CONSTRUCTION

1	20/08/2021	DRAINAGE PIPE SIZES CORRECTED	EST
0	20/08/2021	ISSUED FOR CONSTRUCTION - CONTRACTOR	EST
VER	DATE	REVISION	APPD.

LEGEND DENOTES 20mm CLASS 2 FCR BACKFILL

hillstowe Coords: MGA Levels: AHD CHECKED:

T4YLORS DESIGNED: LOD AUTHORISED: JOY DRAFTED:

AUTH. DATE: 18/09/2020

HORIZ

SCALE 1:500 AT A1 SIZE SCALE 1:1000 AT A3 SIZE

SCALE 1:50 AT A1 SIZE SCALE 1:100 AT A3 SIZE

WGO


CAD REF:

CARDINIA SHIRE COUNCIL 415 PRINCES HIGHWAY, OF HILLSTOWE ESTATE.

CONTRACTOR

UNCIL	SCALE	1:500	H, 1:50 V @) A1		
FFICER VIC 3809	VERSION		1			
	SHEET	45	OF	47		
_, STAGE 4	DRAWING No.					

DRAINAGE LONGITUDINAL SECTIONS SHEET 5 OF 6

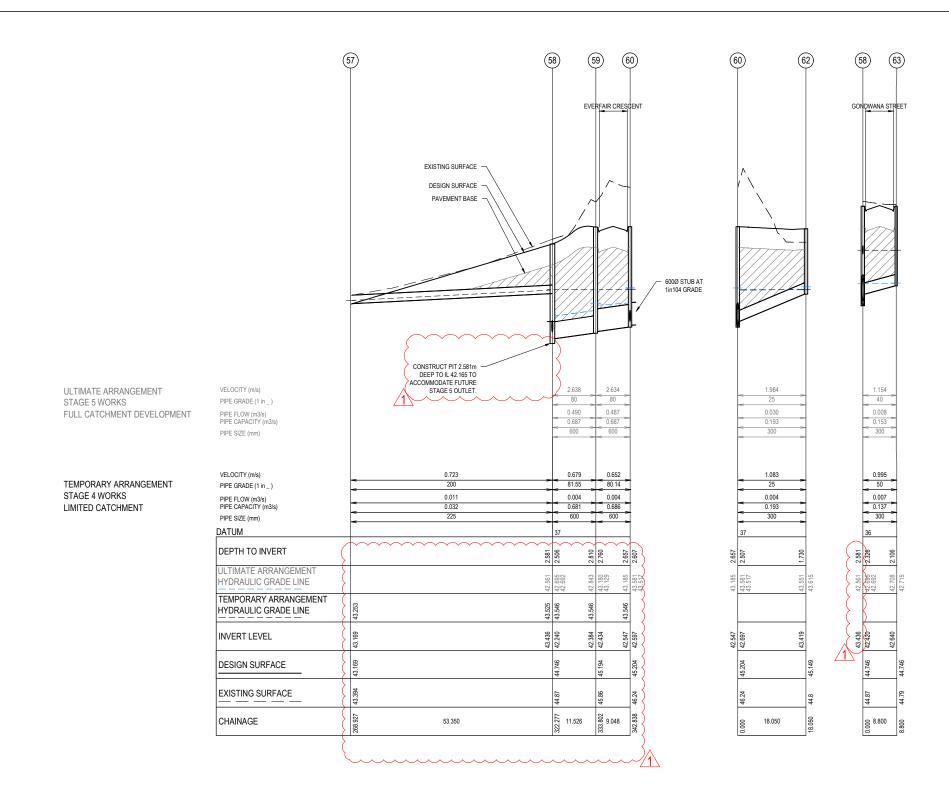



SCALE 1:500 AT A1 SIZE SCALE 1:1000 AT A3 SIZE 20

- PIPE CLASS TO BE CLASS 2 UNLESS NOTED OTHERWISE.
 STRUCTURAL FILL USED ONLY WHEN EXISTING SURFACE IS BELOW FOOTPATH.

WARNING

BEWARE OF UNDERGROUND SERVICES

THE LOCATIONS OF UNDERGROUND SERVICES ARE APPROXIMATE ONLY AND THEIR EXACT POSITION SHOULD BE PROVED ON SITE. NO GUARANTEE IS GIVEN THALL EXISTING SERVICES ARE SHOWN. A MOCS ENQUIRY ON 1100 MUST BE MADE BY THE CONTRACTOR PRIOR TO COMMENCEMENT OF WORKS.

WARNING

IT IS THE RESPONSIBILITY OF THE CONTRACTOR TO VERIFY THE SETOUT INFORMATION PROVIDED ON THIS PLAN WITH THE DESIGN INTENT WHICH INCLUDES, BUT IS NOT LIMITED TO ITEMS SUCH AS LENGTHS, CO-ORDINATES, SETOUT DIMENSIONS AND PEGGED TITLES BY THE PRINCIPAL'S LICENSED SURVEYOR.

CONSTRUCTION ISSUED FOR CONSTRUCTION

				Γ
]
				1
1	10/09/2021	MINOR AMENDMENT TO DRAINAGE	EST	1
0	20/08/2021	ISSUED FOR CONSTRUCTION - CONTRACTOR	EST	1
VER	DATE	REVISION	APPD.	1

LEGEND DENOTES 20mm CLASS 2 FCR BACKFILL

hillstowe DESIGNED: LOD Levels: AHD CHECKED:

T4YLORS AUTHORISED: JOY DRAFTED: WGO

AUTH. DATE: 18/09/2020 CAD REF:

HORIZ.

CARDINIA SHIRE COUNCIL 415 PRINCES HIGHWAY, OFFICER VIC 3809 HILLSTOWE ESTATE, STAGE 4

CONTRACTOR

DRAINAGE LONGITUDINAL SECTIONS


SCALE	1:50	0 H, 1:50 V	/ @ A1
VERSION		1	
SHEET	46	OF	47
DRAWING	No.		

01177-04-E-145

SHEET 6 OF 6

		PIT		INTE	RNAL	IN	LET	OU	TLET	PIT	Г	STANDARD	D5144BV0
~NAME ~	TYRE	EASTING	NORTHING	-WD-	LEN	DIA	INVLEV	DIA~	INV LEV	SETOUT RL	DEPTH	DRAWINGS	REMARKS
4	JP	360384.629	5786366.656	1500	900	825	37.632	1200X450	37.582	39.602	2.021	EDCM607	HAUNCHED JUNCTION PIT
-	ID.				000								
5	JP	360389.913	5786415.346	1050	900	825	37.942	825	37.892	41.279	3.387	EDCM607	HAUNCHED JUNCTION PIT
<u> </u>	ساف	360395.268	5786464.685	1850	_900~	825	38.157	825	38.107	42.462	4.355	EDCM608	HAUNCHEDJUNCTION PIT
7	JP	360392.123	5786468.597	1350	900			825	38.175	42.441	4.266	EDCM608	HAUNCHED JUNCTION PIT
						825	38.225						
8	JP	360313.539	5786485.699	1050	900	825	38.543	825	38.493	41.454	2.961	EDCM607	HAUNCHED JUNCTION PIT
9	JP	360297.462	5786489.198	1050	900	825	38.642	825	38.592	41.251	2.659	EDCM607	
						525	38.750			41.251	2.659		
10	GP	360234.955	5786502.801	1050	900	825	38.905	825	38.855	40.464	1.745	EDCM607	HAUNCHED JUNCTION PIT. GRATED PIT COVER ON 600 SHAFT PIT TO BE CONSTRUCTED TO EXISTING SURFACE RL40.600) AND LOWERED TO DESIGN SURFACE (IE RL4
													DURING STAGE 7 WORKS
						225	39.200						
10A	GP	360260.294	5786535.006	600	900			225	40.125	40.957	0.832	EDCM607	TEMPORARY RETARDING BASIN OUTLET. JUNCTION WITH GRATED PIT COVER. BOLT STEEL PLATE ORIF OVER PIT OUTLET WITH A DIAMETER OF 105MM PIT TO BE CONSTRUCTED TO EXISTING SURFACE
11	JP	360225.878	5786517.835	1050	900	600	39.020	825	38.970	40.375	1.820	EDCM607	RL40.790) AND LOWERED TO DESIGN SURFACE (IE RL4 DURING STAGE 7 WORKS
12	JP	360231.213	5786551.968	900	900	600	39.850	600	39.800	41.691	2.301	EDCM607	PIT TO BE CONSTRUCTED TO EXISTING SURFACE (RL42.100) AND LOWERED TO DESIGN SURFACE (IE RL4 DURING STAGE 7 WORKS
13	JP	360236.186	5786583.783	900	900	600	41.162	600	41.112	43.352	2.240	EDCM607	HAUNCHED JUNCTION PIT
14	GSEP	360239.135	5786602.653	1050	900	600	41.849	600	41.799	44.188	2.389	EDCM603 & 607	HAUNCHED JUNCTION PIT
						300	42.064			44.188	2.389		
15	GSEP	360248.275	5786609.321	900	1200	600	42.131	600	42.081	44.738	2.657	EDCM603 & 607	HAUNCHED JUNCTION PIT
16	GSEP	360249.680	5786618.313	900	900	450	42.477	600	42.402	44.738	2.335	EDCM603 & 607	HAUNCHED JUNCTION PIT
						600	42.452			44.738	2.335		
17	DGSEP	360242.863	5786627.475	900	900	375	42.827	450	42.777	44.627	1.849	EDCM604 & 607	HAUNCHED JUNCTION PIT
						450	42.827			44.627	1.849		
18	JP	360245.250	5786642.747	600	900	300	43.393	375	43.343	45.189	1.847	EDCM605	
						375	43.392			45.189	1.847		
19	GSEP	360255.928	5786711.068	600	900	300	46.873	300	46.823	49.310	2.487	EDCM603	
						300	47.476			49.310	2.487		
20	GSEP	360268.199	5786789.565	600	900	300	49.671	300	49.621	51.698	2.077	EDCM603	
21	GSEP	360259.503	5786790.924	600	900			300	50.023	51.673	1.649	EDCM603	
22	GSEP	360230.292	5786604.035	600	900			300	42.362	44.184	1.822	EDCM603	
23	GSEP	360290.386	5786611.951	900	900	600	42.914	600	42.864	44.944	2.079	EDCM603	HAUNCHED JUNCTION PIT
24	DGSEP	360299.525	5786618.619	900	900	600	43.080	600	43.030	44.787	1.757	EDCM604	HAUNCHED JUNCTION PIT
25	GSEP	360302.060	5786633.868	900	900	450	43.285	600	43.235	44.986	1.751	EDCM603	
26	DGSEP	360308.878	5786677.488	600	900	300	45.126	450	45.051	47.067	2.017	EDCM604	
						300	45.126			47.067	2.017		
27	GSEP	360318.336	5786738.004	600	900	300	47.540	300	47.490	49.244	1.754	EDCM603	
	JOLI	000010.000	5.55.50.004	550		300	47.540			49.244	1.754	250000	
28	GSEP	360321.155	5786756.035	600	900	300	47.955	300	47.905	49.645	1.734	EDCM603	
20	JOLI	5550£1.100	5,50,00,000	300	300	300	47.955	500	11.500	49.645	1.741	25011000	
29	GSEP	360314.361	5786765.346	600	900	300	48.240	300	48.190	50.116	1.926	EDCM603	
30	GSEP	360314.301	5786773.892	600	900	555	10.240	300	48.364	50.116	1.782	EDCM603	HAUNCHED JUNCTION PIT
31	JP	360299.831	5786499.806	900	900	600	39.235	525	39.185	41.284	2.099	EDCM605	CONSTRUCT HAUNCHED JUNCTION PIT TO EXISTIN SURFACE. PIT TO BE CONVERTED AND LOWERED DU STAGE 7 WORKS
32	JP	360306.460	5786542.231	900	900	600	40.916	600	40.866	42.757	1.891	EDCM605	CONSTRUCT HAUNCHED JUNCTION PIT TO EXISTIN SURFACE. PIT TO BE CONVERTED AND LOWERED DU STAGE 7 WORKS
33	GSEP	360311.435	5786574.045	900	900	525	41.870	525	41.820	43.947	2.127	EDCM603	HAUNCHED JUNCTION PIT
						300	41.920			43.947	2.127		
34	GSEP	360302.802	5786575.799	900	600			300	42.164	43.966	1.802	EDCM603	
35	GSEP	360314.075	5786590.940	900	900	525	42.392	525	42.342	44.717	2.375	EDCM603 & 607	HAUNCHED JUNCTION PIT
						300	42.392			44.717	2.375		
						300	42.392			44.717	2.375		
36	GSEP	360315.161	5786607.926	900	900	525	42.691	525	42.641	45.065	2.425	EDCM603	HAUNCHED JUNCTION PIT
·-						450	42.686		1	45.065	2.425		
37	GSEP	360355.274	5786601.656	900	900	450	43.147	450	43.097	45.268	2.172	EDCM603	HAUNCHED JUNCTION PIT
						525	43.315	525	43.265	45.004	1.739	EDCM604 & 607	HAUNCHED JUNCTION PIT

								PIT SCI	HEDULE				
	!	PIT		INTE	RNAL	IN	LET	OUTLET PIT		OTANDAND		REMARKS	
NAME	TYPE	EASTING	NORTHING	WD	LEN	DIA	INV LEV	DIA	INV LEV	SETOUT RL	DEPTH	DRAWINGS	
39	GSEP	360367.435	5786626.686	600	900	450	43.549	525	43.545	45.293	1.748	EDCM603	PROVIDE 450 DIA. STUB AT IL43.549 CAPPED FOR FUTURE CONNECTION
40	JP	360274.445	5786638.184	600	900	300	43.936	375	43.886	45.493	1.606	EDCM605	
41	JP	360280.422	5786676.420	600	900	300	46.321	300	45.696	47.985	2.290	EDCM605	
42	JP	360288.374	5786727.302	600	900			300	48.730	49.774	1.044	EDCM605	
43	GSEP	360317.572	5786676.129	600	900			300	45.224	47.067	1.844	EDCM603	
44	JP	360283.015	5786743.524	600	900			300	49.129	50.255	1.126	EDCM605	
45	GSEP	360329.849	5786754.676	600	900			300	48.150	49.645	1.495	EDCM603	
46	DGSEP	360234.162	5786628.835	600	900			450	42.925	44.627	1.702	EDCM604	
47	GSEP	360247.234	5786712.427	600	900			300	47.586	49.310	1.724	EDCM603	
48	DGSEP	360308.368	5786617.237	600	900	375	43.248	450	43.198	44.780	1.581	EDCM604	
49	JP	360311.218	5786635.473	600	900	375	43.759	375	43.709	45.084	1.375	EDCM605	
50	JP	360337.153	5786631.419	600	900	375	44.382	375	44.332	45.415	1.083	EDCM605	
51	JP	360343.901	5786674.595	600	900	300	45.630	375	45.555	47.572	2.017	EDCM605	
52	JP	360350.387	5786716.091	600	900			300	47.333	48.646	1.313	EDCM605	
54	GSEP	360323.386	5786597.733	600	900			300	42.968	45.114	2.145	EDCM603	
55	GSEP	360305.381	5786592.299	600	900			300	42.832	44.717	1.885	EDCM603	
56	DGSEP	360373,279	5786607.091	600	900			375	43,491	45,004	1.513	EDCM604	
57	END OF LINE	360376.973	5786527.111	-	-	225	43.169			43.169	-	-	DAYLIGHT PIPELINE FOR TEMPORARY STAGE 4 WORKS OUTFALL TO DRAIN INTO TEMPORARY RETARDING BASIN
58	GSEP	360385.212	5786579.821	900	1200	600	42.240	225	43.436	44.746	2.851	EDCM603 & 607	HAUNCHED JUNCTION PIT. CONSTRUCT PIT 2.815M DEEP TO IL 42.165 TO ACCOMMODATE FUTURE OUTFALL
						300	42.420			44.746	-		
59	GSEP	360394.522	5786586.615	900	1200	600	42.434	600	42.384	45.194	2.810	EDCM603 & 607	HAUNCHED JUNCTION PIT.
60	GSEP	360397.907	5786594.993	900	900	300	42.697	600	42.547	45.204	2.657	EDCM603 & 607	HAUNCHED JUNCTION PIT. PROVIDE 600 DIA. STUB AT IL 42.597 CAPPED FOR FUTURE
(600	42.597						
62	GSEP	360376.517	5786581.18	600	900			300	43.419	45.149	1.730	EDCM603	
63	GSEP	360376.517	5786581.180	600	900			300	42.640	44.746	2.106	EDCM603	
TP2	TP	360391.091	5786354.938			1200X450	37.539	1200X450	37.539	38.708	1.169		
TP1	TP	360384.37	5786364.269			1200X450	37.575	1200X450	37.575	39.518	1.944		
NOTE:													
1. XY SETOUT TO F	IT CENTRE												
2. SETOUT LEVEL	TO PIT COV	ER LEVEL											

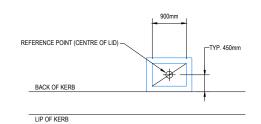

PIT SETOUT POINT SCALE 1:50 @ A1

LEGEND:

JP JUNCTION PIT
GJP GRATED JUNCTION PIT
GSEP GRATED SIDE ENTRY PIT
DGSEP DOUBLE GRATED SIDE ENTRY PIT

DIAL BEFORE YOU DIG WWW.1100.com.au

WARNING

BEWARE OF UNDERGROUND SERVICES

THE LOCATIONS OF UNDERGROUND SERVICES ARE APPROXIMATE ONLY AND THEIR EXACT POSITION SHOULD BE PROVED ON SITE. NO GUARANTEE IS GIVEN THAT ALL EXISTING SERVICES ARE SHOWN. A MOCS ENQUIRY ON 1100 MUST BE MADE BY THE CONTRACTOR PRIOR TO COMMENCEMENT OF WORKS.

WARNING

IT IS THE RESPONSIBILITY OF THE CONTRACTOR TO VERIFY THE SETOUT INFORMATION PROVIDED ON THIS PLAN WITH THE DESIGN INTENT WHICH INCLUDES, BUT IS NOT LIMITED TO ITEMS SUCH AS LENGTHS, CO-ORDINATES, SETOUT DIMENSIONS AND PEGGED TITLES BY THE PRINCIPAL'S LICENSED SURVEYOR.



CONSTRUCTION ISSUED FOR CONSTRUCTION

2	07/09/2021	MINOR AMENDMENT TO OUTFALL DRAIN	EST	
1	20/08/2021	DRAINAGE PIPE SIZES CORRECTED	EST	
0	20/08/2021	ISSUED FOR CONSTRUCTION - CONTRACTOR	EST	
VER	DATE	REVISION	APPD.	

by AVID Property Group

DESIGNED: LC

Coords: MGA Levels: AHD CHECKED: MI

TAYLORS)
Urban Development Infrastructure	
8 / 270 Ferntree Gully Road, Notting Hill, Victoria, 3168 Tel: 61 3 9501 2800 Web: taylorsds.com.au	

8/2/0 Femmree Guilly Road, Notting Hill, Victoria, 3168 Tel: 61 3 9501 2800 Web: taylorsds.com.au								
.OD	AUTHORISED:	JOY	DRAFTED:	WGO				
MO	AUTH. DATE:	18/09/2020	CAD REF:	01177-04-E-146				

CARDINIA SHIRE COUNCIL
415 PRINCES HIGHWAY, OFFICER VIC 3809
HILLSTOWE ESTATE, STAGE 4

CONTRACTOR

SCALE		1:50 @ A1		_
VERSION		2		_
SHEET	47	OF	47	_
DRAWING	No.			

DRAINAGE PIT SCHEDULE

N.T.S

Schedule 8: Drawing Schedule

Drawing No.	Sheet No.	Title
20PD2713/S1	1	NOTES, SCHEDULES & LOCALITY PLAN
20PD2713/S2	2	DETAIL PLAN
20PD2713/S3	3	LONGITUDINAL SECTIONS SHEET 1 OF 2
20PD2713/S4	4	LONGITUDINAL SECTIONS SHEET 2 OF 2

MELWAYS: 214 H3

SCALE:



WARNING

BEWARE OF UNDERGROUND SERVICES THE LOCATION OF UNDERGROUND SERVICES ARE APPROXIMATE ONLY AND THEIR EXACT POSITION SHOULD BE PROVEN ON SITE. NO GUARANTEE IS GIVEN THAT ALL EXISTING SERVICES ARE SHOWN.

General Notes:

- Only contractors accredited by South East Water to SC1 and SC7 shall be eligible to construct these works.
- Only products approved and catalogued by the Water Agency shall be used.
- Works must be to constructed according to the MRWA edition of the WSAA Sewerage code of Australia WSA 02-2014-3.1.
- The design consultant is responsible for the design and coordination of the works. Any problem arising during construction shall be directed to the consultant.

Survey, Set Out and Asset Recording

- All contours and levels are in metres to the Australian height datum (A.H.D.)
- 6. All co-ordinates shown are to map grid of Australia (MGA).
- Chainages shown on detail plans are discontinuous at maintenance structures.
- Chainages shown on long section sheets are continuous.

 8. Coordinates are to sewer line intersection point unless otherwise
- Before commencement of work, the contractor must complete a level check between all TBM's to verify level values.
- TBM's and control points are to be maintained and protected at all times during construction.

Should any marks be disturbed, the contractor will immediately notify the consultant to arrange re-instatement at the contractors expense.

Property Connections

- 11. Number of lots to be sewered: 37 + 20 future lots
- 12. All property connections to be DN100 unless otherwise indicated.
- 13. Properties requiring boundary traps are indicated in the detailed plans. The remainder do not require boundary traps.
 14. Branch tie distance shown on detail plan are from approved
- subdivision survey pegs. Branch ties for future lots are shown as a chainage. (Ch) Distance is from the downstream sewer structure.

 15. Invert level of the property connection point is shown opposite the
- branch position.

 16. Where a Spur Branch connects to a shaft, both property connections are considered to be shaft connections

Earthworks and Retaining Walls:

 In areas subject to earthworks, construction of sewers shall not commence until earthworks has been completed unless written approval has been given by the Water Authority.

Embedmen

 Embedment shall be Type A (refer MRWA-S-202) unless otherwise specified on the long section.

Backfill

- Selection and compaction of trench backfill material shall be in accordance with the Water Agency adopted version of MRWA specification no 04-03.
- 20. Refer to Long Section drawings for backfill requirements.

Compaction Testing

- 21. Test results shall be provided to the superintendent prior to practical completion / acceptance of works.
- The contractor is required to undertake all testing of fill compaction in accordance with the Water Agency adopted version of the MRWA Backfill Specification 04-03.

Work on Live Sewers:

- 23. All works on live sewers must be carried out by a water company
- All existing sewers must be plugged to stop gas emissions prior to any connections being made to these sewers.

- 25. To enable connections to live assets or any work on live assets, the contractor shall submit the appropriate forms to the superintendent at least 3 working days prior to any works on live sewers.
- The contractor is not permitted to break into an existing live
 pipeline, enter a live sewer or remove the cover to a live
 maintenance structure unless authorised by the Water Agency.

Safety:

27. Prior to commencement of works on site, the contractor must ensure that all matters relating to the Occupational Health and Safety Act 2004 and Occupational Health and Safety regulations 2007, have been and will be complied with.

Testina

 The contractor is to give a minimum of two (2) days notice to the superintendent and Water Agency prior to the testing being undertaken. Testing is to be undertaken in the presence of superintendent.

Cultural Heritage Requirements

 The contractor is to keep a copy of the approved cultural heritage management plan on site at all times during works.

Environmental Management Plan:

- On commencement of construction works the contractor must comply with the recommendations of the EPA publication "construction techniques for sediment pollution control" (publication no 275 1991).
- 31. All trees and vegetation are to be protected unless otherwise indicated for removal.
- The extent of any vegetation removal shall be confirmed on site with the superintendent and local council prior to commencement, and in accordance with any planning permits. Any removal shall be documented.
- All areas containing creek vegetation, trees and revegetated areas near the construction zone are to be fenced off during the works with secure and highly visible material such as para-webbing fencing.
- Ensure all machinery, equipment and/or footwear entering the site is weed and pathogen free.

Schedule 1: New Pip	Schedule 1: New Pipe									
Pipe Size	Pipe Type	Length (m)	Pipe Class	Standard						
DN150	UPVC-DWV	556.2	SN8	WSA PS 230						
DN100	LIPVC-DWV	18.2	SN10	WSA PS 230						

Schedule 2: Pro	operty Conr	nections				~~~	$\sqrt{2}$	(~~~	<u>/2</u> \
Connection Type	Type 1a	Type 1b	Type 2	Type 4a	Type 4b	Type S	Type 4S	Type B (, , , ,	Jump Up Type F Couplings (TY2 or 4)
Quantities	1	2	38	-	1	. 7	K -	1	7	8

Schedule 3: Road Reserve Service Offsets (m) and Locations:												
Street	Ga	s	Wa	ter	ND	W	Cor	nms	Ele	C.	Light	ting
Everfair Crescent (Lots 418-426 & 401)	E	2.10	Е	3.10	Е	2.50	W	1.00	W	2.60	1.0	ВОК
Everfair Crescent (Lots 412-418 & 434-437)	N	2.10	N	3.10	N	2.50	S	1.80	S	2.60	1.0	BOK
Clearfell Street (Lots 403-412)	W	2.10	W	3.10	W	2.50	Е	1.80	Е	2.60	1.0	BOK
Clearfell Street (Lots 401-403)	S	1.95	S	2.95	S	2.35	N	1.00	N	0.50	1.0	BOK
Kielder Street	E	2.10	Е	3.10	Е	2.50	W	1.80	W	2.60	1.0	BOK
Sawmiller Street	E	2.10	Е	3.10	Е	2.50	W	1.80	W	2.60	1.0	BOK
Gondwana Street	E	2.10	Е	3.10	Е	2.50	W	1.80	W	2.60	1.0	BOK
Applebush Walk	S	1.85	S	2.75	S	2.25	S	3.35	S	3.75	1.0	BOK

Maintenance Structure	Туре	Cover Class	Depth to Invert	Shaft Connections	Easting	Northing	Comments/ References (Offsets/Details)
ABC4-1MS	MS	В	2.651	-	360364.690	5786624.990	4-WAY MS
ABC1-3MS	MS	В	2.854	-	360357.508	5786604.090	-
ABC1-2MC	MC	В	3.071	1xDN100	360326.750	5786608.898	-
ABC2-2MS	MS	В	2.201	2xDN100	360275.984	5786642.195	4-WAY MS
ABC2-3MS	MS	В	2.303	2xDN100	360287.256	5786714.319	4-WAY MS
ABC2-4MS	MS	В	1.549	-	360291.472	5786741.292	4-WAY MS
ABC4-3MS	MS	В	2.926	1xDN100	360338.691	5786635.430	4-WAY MS
ABC4-4MS	MS	В	2.393	1xDN100	360347.107	5786689.276	-
ABC6-1MS	MS	В	2.071	-	360371.025	5786587.808	-

Schedule 5: Water Agency Granted Dispensations

ID	Location	Asset / Feature	Description of Dispensation Accepted
117669	LOT 437	Reduced Offset	Accepted

Schedule 6: Maintenance Holes													
Maintenance Structure	MH Type	MH Top Type	Cover Class	Internal Diameter	Min Wall Thickness	Depth Lowest Invert	Drops	Ladder, Step Irons, Landing	Corrosion Protection	Shaft Reinforcement	Comments (Offsets/Details)	Easting	Northing
ABC1-1MH	MH	Conical	В	1050	150	3.311	1xDN150	S	-	-	-	360244.746	5786621.71
ABC1-4MH	MH	Conical	В	1050	150	1.584	1xDN100	S	-	-	-	360399.072	5786597.594
ABC2-1MH	MH	Conical	В	1050	150	2.461	-	S	-	-	-	360248.106	5786643.212
ABC4-2MH	MH	Conical	В	1050	150	2.644	-	S	-	-	-	360365.154	5786627.954
ABC4-5MH	MH	Conical	D	1050	150	2.229	-	S	-	-	-	360354.442	5786736.20
ABC5-1MH	MH	Conical	В	1050	150	2.489	-	S	-	-	-	360378.522	5786622.826

Schedule 7: Water Seals, Boundary Traps and Syphons							
Structure Type Boundary Trap Water Seals Syphons							
Quantity 0 0 0							

CONTRACTOR

ISSUED FOR CONSTRUCTION

								DESIGNED	L.DUNN DATE: 11/05/2021	PROJECT NUMBER	01177-04-E
2	AMENDED PROPERTY CONNECTIONS	27/10/2021	MIO					DRAWN	W.GOH	MELWAY	214 H3
1	ISSUED FOR CONSTRUCTION - CONTRACTOR	15/09/2021	MIO						DATE: 14/05/2021	REFERENCE	214 113
0	ISSUED FOR CONSTRUCTION	15/06/2021	MIO					CHECKED		AUTHORISED	J.YALDEN
REV	DESCRIPTION	DATE	APPROVED	REV	DESCRIPTION	DATE	APPROVED		M.OLTHOF DATE: 15/06/2021		J. YALDEN DATE: 18/09/2020








SOUTH EAST WATER CARDINIA SHIRE COUNCIL

CARDINIA SHIRE COUNCIL
415 PRINCES HIGHWAY, OFFICER VIC 3809
HILLSTOWE ESTATE, STAGE 4
NOTES, SCHEDULES & LOCALITY PLAN
SEWER RETICULATION

SCALE: AS SHOWN	I @A3
SHEET: 1 OF 4	
DRAWING No.:	REV
20PD2713	2
S1	

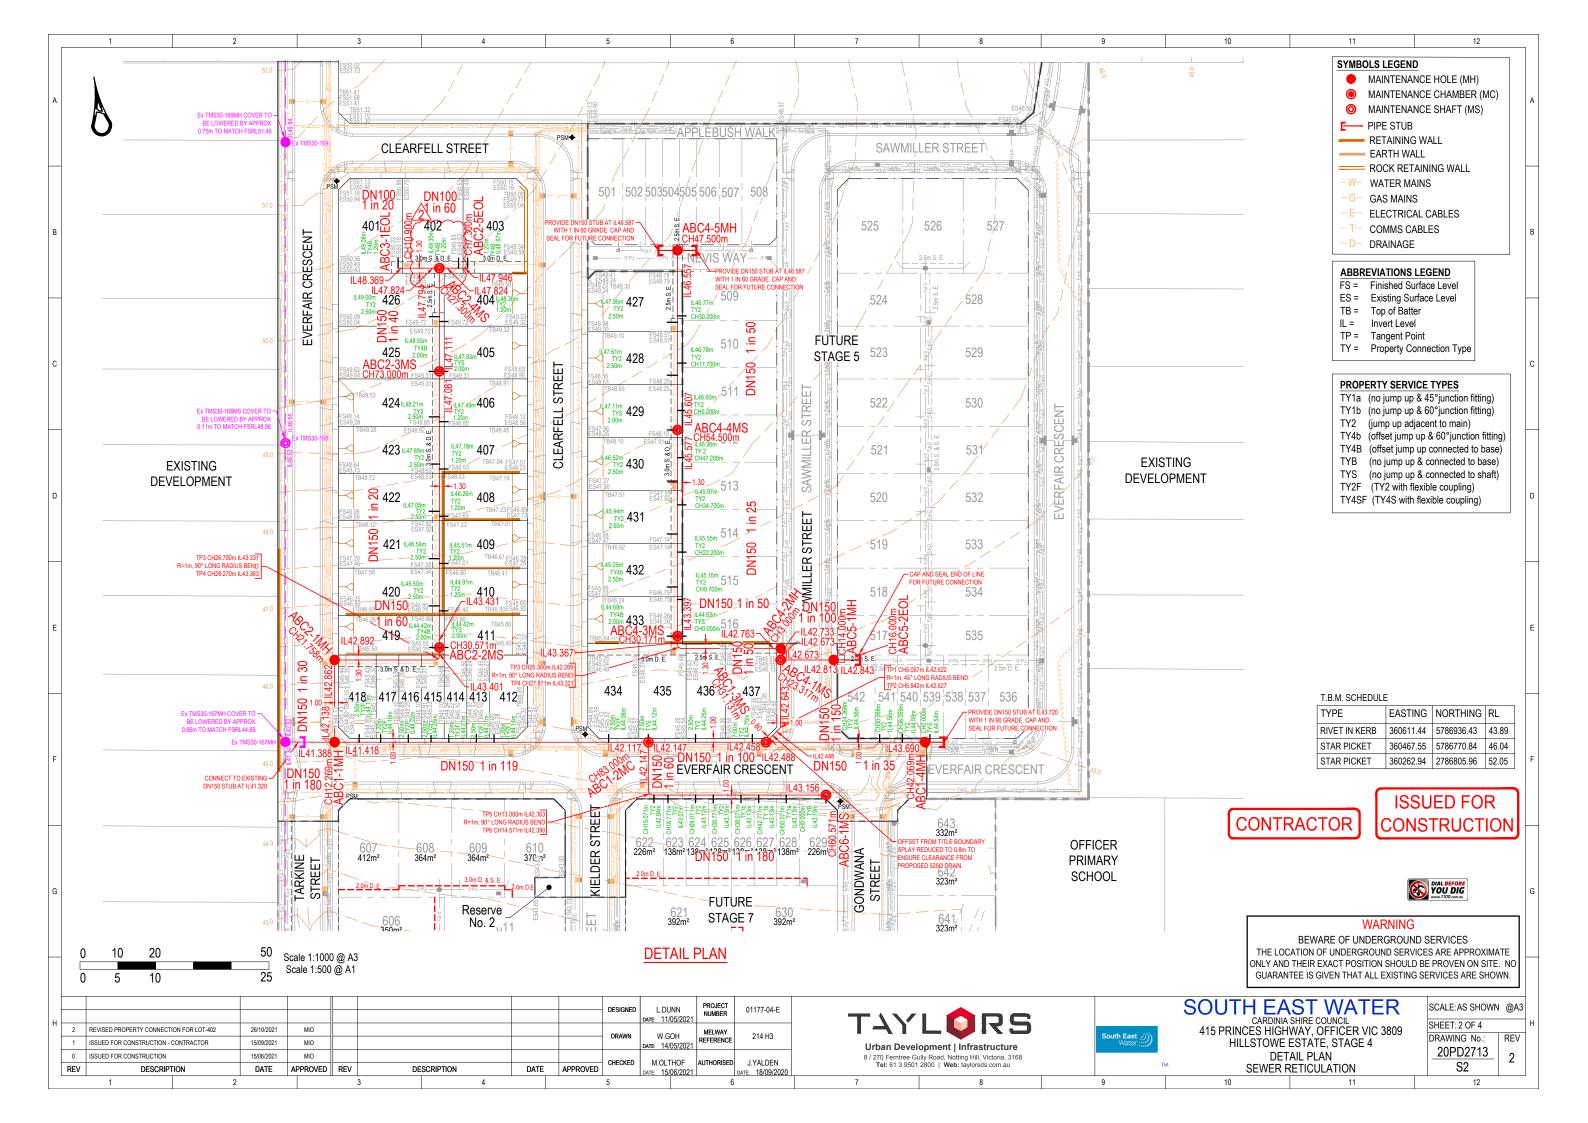

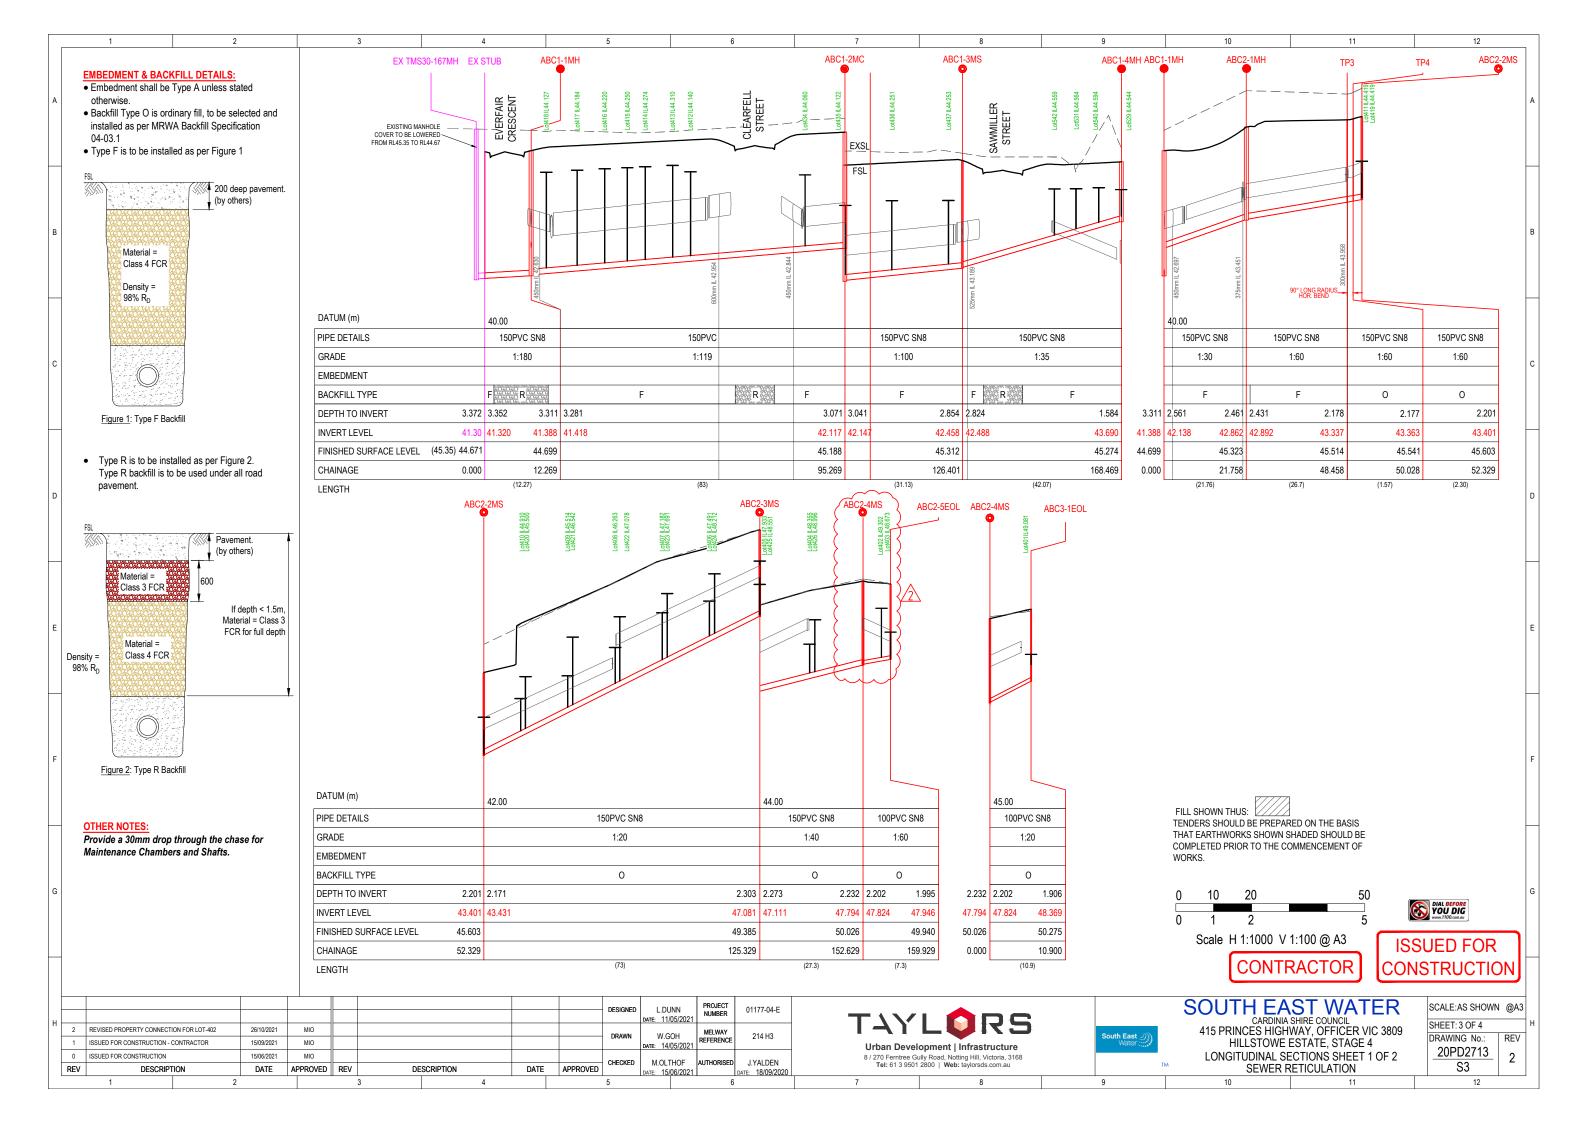

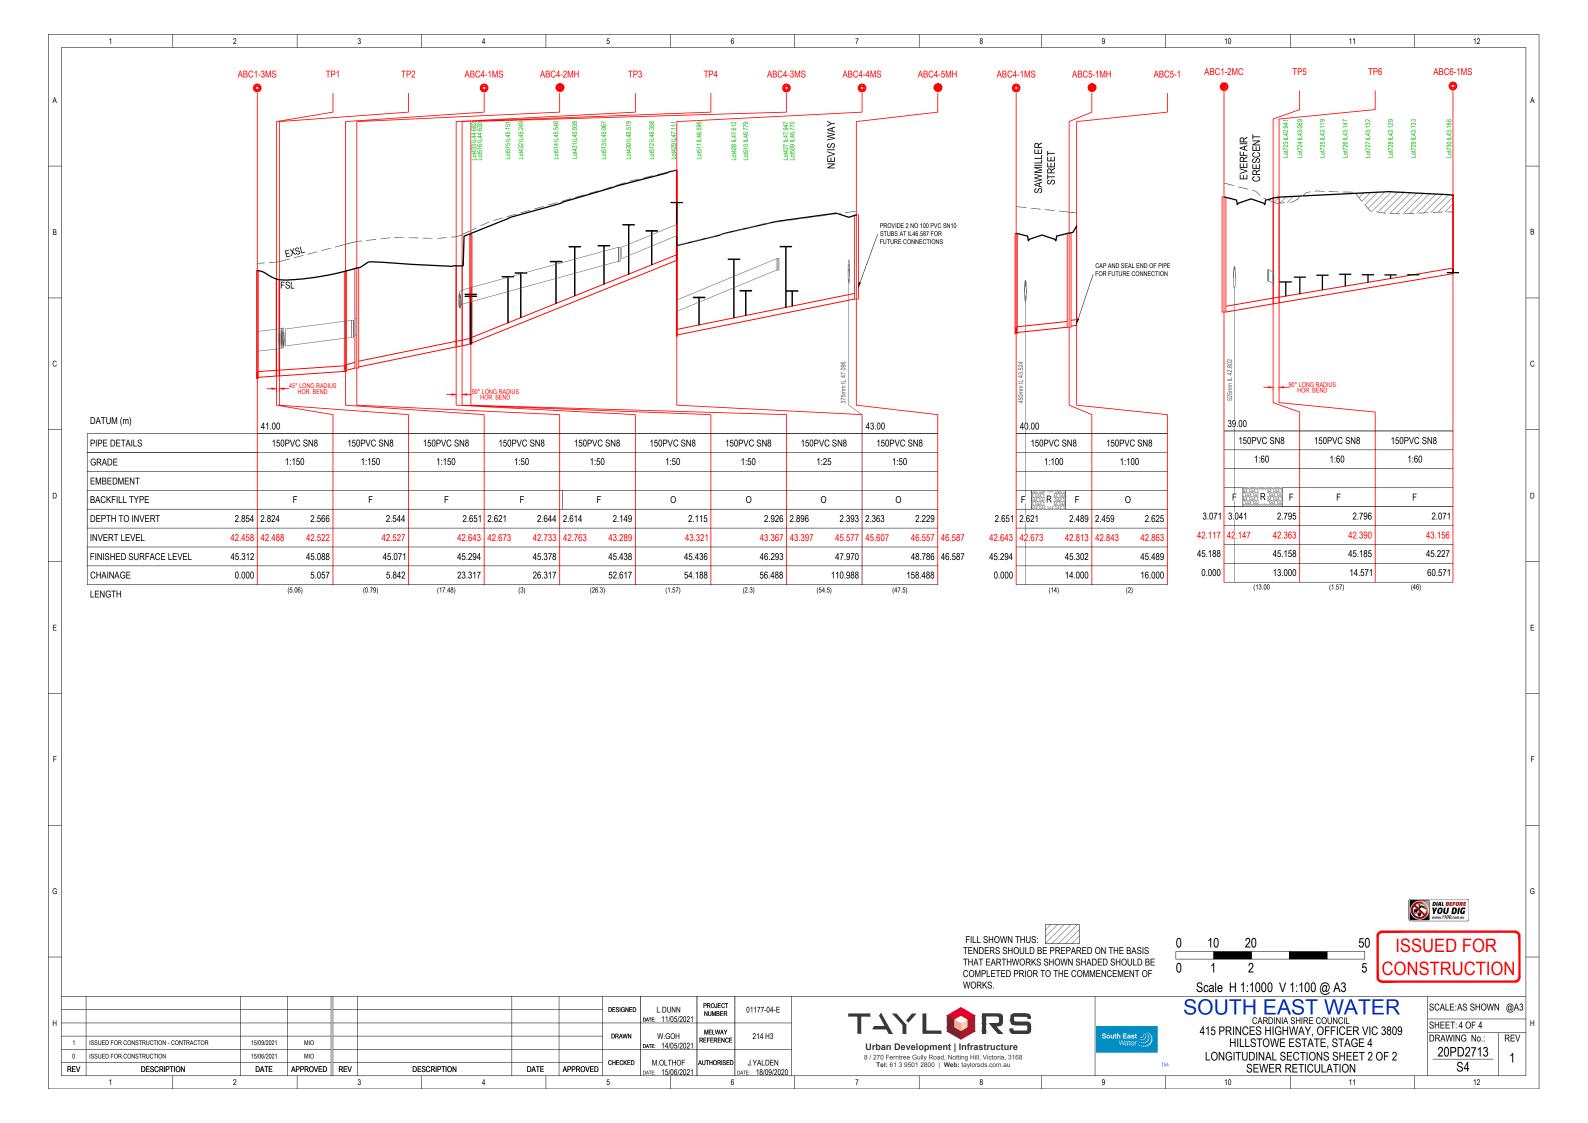

DESIGN HEAD: ZONE:

TEST PRESSURE:

63 m RESIDENTIAL 1000 kPa

NON-DRINKING WATER

DESIGN HEAD: ZONE:

SCALE:

MELWAYS:

WARNING

BEWARE OF UNDERGROUND SERVICES THE LOCATION OF UNDERGROUND SERVICES ARE APPROXIMATE ONLY AND THEIR EXACT POSITION

SHOULD BE PROVEN ON SITE. NO GUARANTEE IS

GIVEN THAT ALL EXISTING SERVICES ARE SHOWN.

WARNING BEWARE OF ASBESTOS SOME UNDERGROUND SERVICES MAYBE CONSTRUCTED FROM ASBESTOS CONTAINING MATERIAL. CONTACT THE SUPERINTENDENT FOR INSTRUCTIONS ON HOW TO MANAGE ANY POTENTIAL ASBESTOS HAZARD

YOU DIG

FOR THE DURATION OF PROCLAIMED WATER

RESTRICTIONS, THE CONTRACTOR SHALL CONFORM

WITH THE RESTRICTIONS AND ANY OTHER WATER

CONSERVATION REQUIREMENTS IMPOSED BY THE WATER AGENCY.

58 m RESIDENTIAL

TEST PRESSURE: 1000 kPa



N.T.S.

214 H3

- Only contractors accredited by South East Water to WC1 shall be eligible to construct these works.
- 2. Only products approved and catalogued by the Water Agency shall be used.
- 3. Works must be constructed according to WSA 03- 2011 MRWA edition.
- The Contractor shall ensure that they are conversant with all current revisions, amendments and updates that the relevant Water Agency has made to their standards.
- 4. DW and NDW assets shall only be constructed after deeper assets affecting the water mains have been constructed (eg. sewerage & drainage assets).
- 5. This design is to be read in conjunction with road and drainage plans.
- 6. The Contractor shall obtain a road opening permit for any works within the road reserve and comply with all requirements of the road owner.

Survey, Set Out and Asset Recording

- 7. Temporary Bench Marks (TBM) for the set out of works to the Australian Height Datum (AHD) are provided in the design drawings. All levels are in metres to AHD.
- All co-ordinates are in metres to the Map Grid of Australia
- The Contractor is directly responsible for ensuring the project set out is consistent with the design. Should actual site conditions conflict in any way with that documented, the Contractor shall contact the Superintendent for clarification before proceeding
- 10. The Contractor is to engage a suitably qualified and experienced Surveyor to undertake asset recording of the work. All surveyor works and data recording shall be undertaken in accordance with the MRWA survey manual.
- 11. All specific pipe materials (eg: PVC-O) shall be indicated in the As Constructed information

Products and Materials (Refer Table 1 & 2)

12. DW and NDW system components shall be differentiated as per section 4.2 of WSA03-2011, MRWA edition.

Appurtenances (Fittings- Refer Table 3)

Water Main Alignment, Trenching & Cover (Refer Table 5)

- 13. Offsets of mains from property boundaries shall be; min 600mm (mains < DN100) and min 1m (mains ≥DN100).
- 14. All water mains shall pass over drains and sewers unless shown otherwise in the design drawings.

Table 7. Vertical Clearances

Minimum vertical				
clearance (mm)				
150				
300				
150				
150				
Minimum vertical				
clearance (mm)				
225				
150				
500				
300				

- Vertical clearance between water mains shall depend on the larger main diameter.
- Water mains shall cross over sewers and drains unless shown otherwise.
- Maintain additional clearance from High Voltage electrical cables to allow for a protective barrier and

15. Embedment shall be placed as per drawings MRWA-W-201 and MRWA-W-202

- 16. Road reserve backfill and compaction shall be in accordance with MRWA-W-201 and MRWA-W-202
- 17 Non trafficable backfill shall be completed as per MRWA-W-201 and the current version of the MRWA Backfill Specification.

Thrust Restraint (Refer Table 6)

18. Thrust restraints have been designed on the basis of the AHBP (ground strength) nominated in TABLE 6. The Contractor shall confirm the actual ground conditions and discuss with the Superintendent any ground conditions which are found to be different to that nominated.

19. NDW property services shall always be located on the left of the DW property service as you look from the road to the front of the property.

onnections (All types)

20. All property service connections to new residential RRJ reticulation mains are to be completed using pretapped connectors.

Other Services (Ref- Table 5 & 7)

- 21. To receive the most up to date information prior to construction, "Dial before you Dig" shall be undertaken to aid in the location of other services. Other services shall be carefully located prior to full excavation at the contractor's cost. Any clashes of proposed new works with other assets shall be reported to the Superintendent immediately for clarification
- 22. Clearances to other services shall be as per Table 7 and Table 5.5 of WSA03- 2011 MRWA edition. These clearances shall apply to surface covers as well as underground assets.

Earthworks and Retaining Walls:

23. In areas subject to earthworks, construction of water assets shall not commence until earthworks and retaining walls has been completed unless written approval has been given by the Water Authority.

Testing, Asset Acceptance and Live Connection

- 24. Post construction activities (of both DW & NDW) such as swabbing, water quality testing, pressure testing and chlorination shall be carried out in accordance with WSA03-2011 MRWA edition and the MRWA Water Quality Compliance Specification. All test results shall be documented and reported to the Superintendent
- 25. The Water Agency shall be notified in writing 2 full working days in advance of testing being undertaken.
- 26. Both ends of DW and NDW main to meter property services shall be inspected by the Water Agency. The Water Agency shall be notified in writing 2 full working days in advance of this inspection being carried out. Both ends of DW-NDW main to meter property services are to remain exposed until inspected by the Water Agency compliance officer.
- 27. The Contractor's ITP shall include provision for each NDW connection to be signed off as correctly installed. The Water Agency shall be notified in writing 5 SEW full working days in advance of connection to the live network being undertaken.
- Shut down work shall be as short as practical and scheduled to commence at 9am on working days with completion to occur no later than 4pm.
- 28. Valves connecting new assets to the Water Agency's live system shall not be operated by the Contractor

Table 1. New Pipe Schedule

	•			
New Work		Drinking Main	Non-drinking Main	
Size (DN)	Туре	Class	Length	Length
150	PVC - M	16	359	358
100	PVC - M	16	255	255
125	PE100	16	70	71
25	PE100	16	Property Services	Property Services

Table 2. Pipe Material Schedule

Material	Reference	Material	Reference
PVC-M	WSA-PS-209	PE (Retic & submain)	WSA-PS-207
		PE (Property services)	WSA-PS-215

Table 3. Hydrant & Washout Schedule

Main Size	Fitting Type	Ownership	Location	Street	Location
100	HYDRANT	DW - SEW	In Line	CLEARFELL STREET	2.0m E of WBL Lot 401 Splay
100	HYDRANT	NDW - Council	In Line	CLEARFELL STREET	2.6m E of WBL Lot 401 Splay
100	HYDRANT	DW - SEW	In Line	CLEARFELL STREET	4.9m W of Applebush Walk WBI
100	HYDRANT	NDW - SEW	In Line	CLEARFELL STREET	4.3m W of Applebush Walk WBI
100	HYDRANT	NDW - Council	In Line	CLEARFELL STREET	4.9m S of NBL Lot 407
150	WASHOUT	DW - SEW	End of Line	EVERFAIR CRESCENT	0.6m E of Title BL
150	WASHOUT	NDW - SEW	End of Line	EVERFAIR CRESCENT	On Title BL
100	WASHOUT	DW - SEW	End of Line	SAWMILLER STREET	3.7m N of Title BL
100	WASHOUT	NDW - SEW	End of Line	SAWMILLER STREET	3.1m N of Title BL
100	HYDRANT	DW - SEW	In Line	GONDWANA STREET	3.1m S of Title BL
100	HYDRANT	NDW - Council	In Line	GONDWANA STREET	3.7m S of Title BL
100	HYDRANT	DW - SEW	In Line	KIELDER STREET	6.0m S of NBL Lot 723 Splay
100	HYDRANT	NDW - Council	In Line	KIELDER STREET	6.6m S of NBL Lot 723 Splay
100	WASHOUT	DW - SEW	End of Line	KIELDER STREET	On Title BL
100	WASHOUT	NDW - SEW	End of Line	KIELDER STREET	0.6m S of Title BL
100	HYDRANT	DW - SEW	In Line	TARKINE STREET	3.7m S of Title BL
100	HYDRANT	NDW - Council	In Line	TARKINE STREET	3.1m S of Title BL
100	HYDRANT	DW - SEW	In Line	TARKINE STREET	6.3m S of Title BL
100	HYDRANT	NDW - SEW	In Line	TARKINE STREET	5.7m S of Title BL

Table 4. Curved Pipe & Deflection Schedule

Location	Method	Offset/Radius (m)	Total Pipe Length (m)	Pipe Lengths (m)
-	-	-	-	-

Table 5. Service Alignment Schedule (offsets in m)

Location	Water	ND-Water	Gas	Comms	Elec	Poles	вок
EVERFAIR CRESCENT (LOTS 418-426 & 401)	3.10 E	2.50 E	2.10 E	1.00 W	2.60 W	1.0 W	BOK
TARKINE STREET	3.10 E	2.50 E	2.10 E	1.00 W	2.60 W	1.0 W	BOK
EVERFAIR CRESCENT (LOTS 412-418 & 434-437)	3.10 N	2.50 N	2.10 N	1.80 S	2.60 S	1.0 E	BOK
CLEARFELL STREET (LOTS 403-412)	3.10 W	2.50 W	2.10 W	1.80 E	2.60 E	1.0 E	вок
CLEARFELL STREET (LOTS 401-403)	2.95 S	2.35 S	1.95 S	1.00 N	0.50 N	1.0 N	BOK
KIELDER STREET	3.10 E	2.50 E	2.10 E	1.80 W	2.60 W	1.0 W	BOK
SAWMILLER STREET	3.10 E	2.50 E	2.10 E	1.80 W	2.60 W	1.0 W	BOK
GONDWANA STREET	3.10 E	2.50 E	2.10 E	1.80 W	2.60 W	1.0 W	BOK
APPLEBUSH WALK	2.75 S	2.25 S	1.85 S	3.35 S	3.75 S	3.5 S	BOK

Table 6. Thrust Restraint Schedule

Location	Туре	Thrust	AHBP (kPa) USED	Area (m²), or W(m) x Y(m)	No. Locations
Α	In Line	2 x (DN125 VALVES + PE THERMAL SHRINKAGE)	50	1.10 (tot)	3
В	Plain	2 x DN100 x DN100 TEES	50	0.46 (tot)	1
С	In Line	2 x DN125 PE THERMAL SHRINKAGE	50	0.86 (tot)	2
D	Plain	2 x DN150 x DN100 TEES	50	0.46 (tot)	2
Е	In Line	2 x DN150 VALVES	50	0.96 (tot)	2
F	In Line	2 x DN100 VALVES	50	0.60 (tot)	2
G	Plain	2 x DN100 WASHOUTS	50	0.46 (tot)	2
Н	Plain	2 x DN150 x DN150 TEE	50	0.96 (tot)	1
- 1	Plain	2 x DN150 WASHOUTS	50	0.96 (tot)	1
J	In Line	2 x DN125 VALVES + PE THERMAL SHRINKAGE + 90° BEND	50	1.74 (tot)	1

ISSUED FOR CONSTRUCTION

PROJECT NUMBER E.STAINES DESIGNED 01177-04-E ATE: 16/09/202 MFI WAY DRAWN W BROWN 214 H3 ATE: 14/09/2020 ISSUED FOR CONSTRUCTION 15/06/2021 CHECKED M.OLTHOF J.YALDEN REV DESCRIPTION DATE APPROVED REV DESCRIPTION DATE APPROVED DATE: 15/06/2021

Urban Development | Infrastructure

8 / 270 Ferntree Gully Road, Notting Hill, Victoria, 3168 Tel: 61 3 9501 2800 | Web: taylorsds.com.au

South East

SOUTH EAST WATER

CARDINIA SHIRE COUNCIL
415 PRINCES HIGHWAY, OFFICER VIC 3809 HILLSTOWE ESTATE, STAGE 4 NOTES, SCHEDULES & LOCALITY PLAN WATER RETICULATION

SCALE: AS SHOWN @A3 SHEET: 1 OF 3 DRAWING No.: REV

0

20PD2713 W1

